## **ARCHITECTURAL PLANS**

PROJECT: **RENOVATIONS & ADDITIONS TO EXISTING DWELLING** 

PROPOSED SECOND DWELLING - TO FORM DUAL OCCUPANCY

PROPOSED SUBDIVISION

3MJ DEVELOPMENTS Pty Ltd FOR:

SITE: 4 Burrundulla Ave Mudgee NSW 2850

Lot 313 DP 1255905

#### DRG No: SHEET DESCRIPTION

- EXISTING SITE PLAN
- 2 **EXISTING DWELLING - FLOOR PLAN & ELEVATIONS**
- 3 PROPOSED SITE PLAN
- LANDSCAPE PLAN
- PRELIMINARY SUBDIVISION PLAN, VEHICLE MOVEMENT ON SITE
- 6 **EROSION CONTROL PLAN**
- 7 DWELLING 1 - PROPOSED FLOOR PLAN
- **DWELLING 1 ELEVATIONS** 8
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- 16 DWELLING 2 - ROOF PLAN, GENERAL NOTES
- 17 DOOR LIST
- 18 WINDOW LIST
- 19 SHADOW DIAGRAM
- 20 GENERIC DRIVEWAY DETAIL









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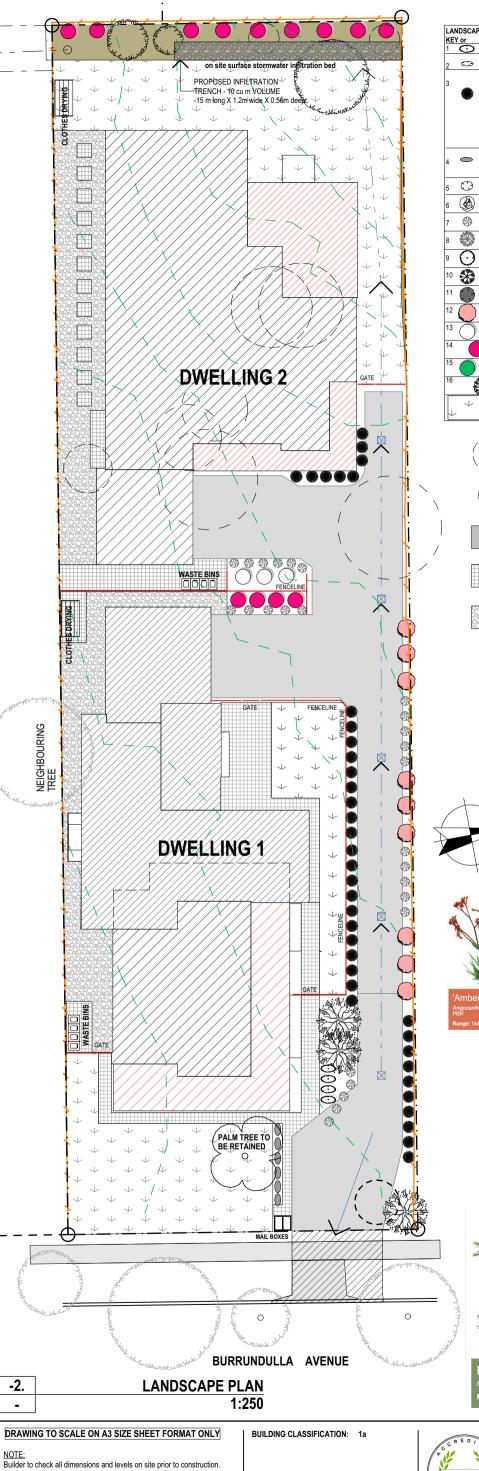
PROJECT No: 112.21

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**Preferred Design** & Drafting





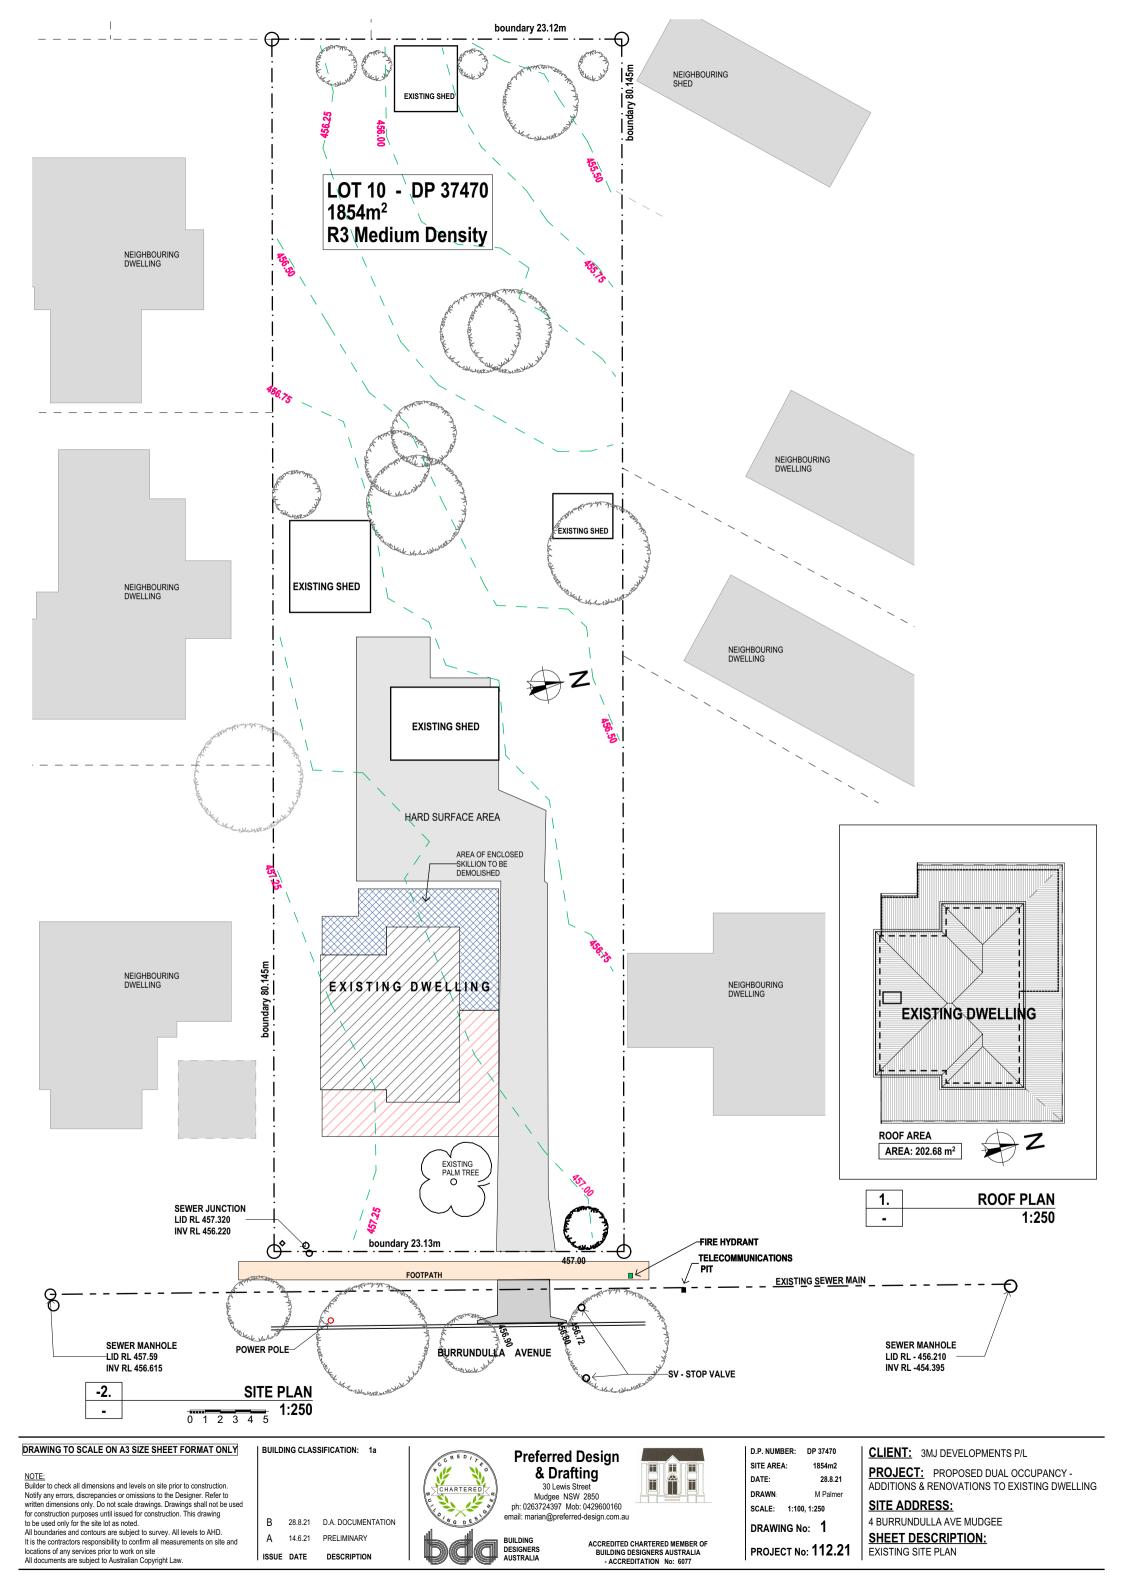

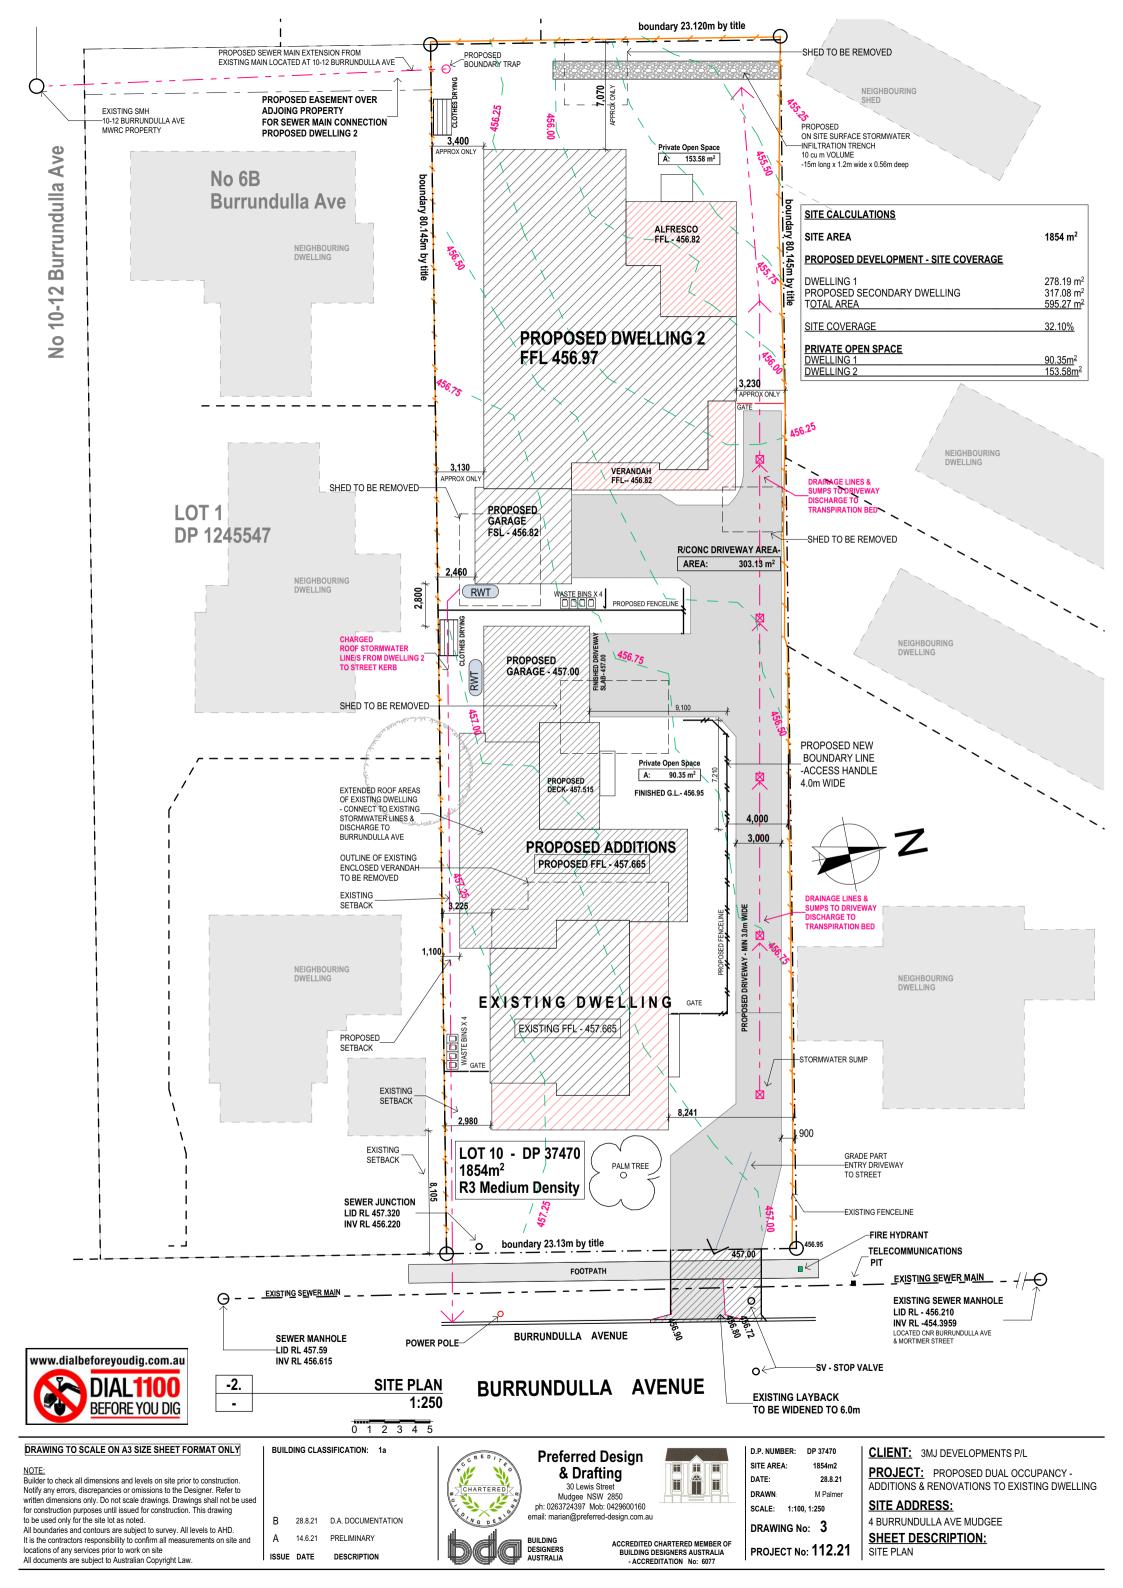KE'	Y or	SYMBOL PLANTING	MATURE SIZE				
l	0	Grevillea poorinda (Royal Mantle)	Prostrate/Ground Cover				
2	0	Myporum Parvifolium purpurea	Ground Cover				
,		(options / selection of grasses & border plantings)					
3	Alla.	Lomandra Longifolia Tanika	250mm				
		Lomandra confertifolia Wingarra	300mm				
		Phormium tenax	800mm				
		Anigozanthos hybrid Amber Velvet Kangaroo Paw	500mm				
		Daniella Caerulea Little Jess	400mm				
		Daniella Cassa Blue	400mm				
		Liriope muscari	450mm				
4		Westringia Blue Gem	1.5m				
•		or fruiticosa	400mm h x 1.5mw				
		or indiacosa	4001111111 X 1.511W				
5	$\odot$	Buxus Japonica (Hedge)	up to 2.0m (trimmed)				
6		Grevillea beadleana	1.5m				
7	\$	Nandina Domestica BLUSH	600mm - 700mm				
8	*	Claret Ash fraxinus rotundifolia 'Raywood'	15m				
9	$\overline{\Omega}$	Acer palmatum Japanese Maple	3.5 - 4.5 m				
10	<u>\$</u>	Callistemon Viminalis	2.0m				
11	445	Oill (Ob	2.4m				
11		Grevillea 'Canberra gem'	2.4m				
12		Syzygium australe 'Pinnacle"	6-10m				
13	$\bigcirc$	Callistemon viminalis	9.0m				
14		Pittosporum Tenuifolium (Silver Sheen)	2.0m-3.0m				
15		Magonlia Grandiflora Little Gem	4.0m				
16		Betula Pendula (Silver Birch)	9.0 - 15.0m				
	<u> </u>	TURF- SIR WALTER (BUFFALO)	3.0 - 13.011				

TREE TO BE REMOVED



TREE TO BE RETAINED



R/CONCRETE



PAVING OR STENCILLED R/CONCRETE



**DECORATIVE GRAVEL** 



#### LANDSCAPE NOTES

All plants to be of premium quality, free from pests, weeds & diseases and any damage.Plants to be established but not pot bound.

Check soil condition and cultivate to: 150mm for groundcovers

300mm for shrubs 500mm for trees

Soil to be imported top soil & comply with AS4419. All soil to be friable & free from any deleterious material & rocks greater that 25mm.

Quality mulch to be added at a depth of 75mm. Garden edging to owners selection.

Ensure all areas are adequately drained. Gardens must fall away from buildings and paving and directed into gully pits.

Improve drainage where necessary.
Ensure all services are located prior to starting project























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Red Fence™ Photinia x fraseri 'CP01' PBR Range: Emporium Range



Notify any errors, discrepancies or omissions to the Designer. Refer to written dimensions only. Do not scale drawings. Drawings shall not be used for construction purposes until issued for construction. This drawing to be used only for the site lot as noted.

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All documents are subject to Australian Copyright Law

D.A. DOCUMENTATION В 28.8.21 14.6.21 PRELIMINARY

DESCRIPTION ISSUE DATE



**Preferred Design** & Drafting

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D.P. NUMBER: DP 37470 SITE AREA: 1854m2 DATE: 28.8.21 DRAWN: M Palmer


SCALE: 1:100, 1:250 DRAWING No: 4


PROJECT No: 112.21


**CLIENT:** 3MJ DEVELOPMENTS P/L

**PROJECT:** PROPOSED DUAL OCCUPANCY -ADDITIONS & RENOVATIONS TO EXISTING DWELLING

**SITE ADDRESS:** 4 BURRUNDULLA AVE MUDGEE **SHEET DESCRIPTION:** LANDSCAPE PLAN

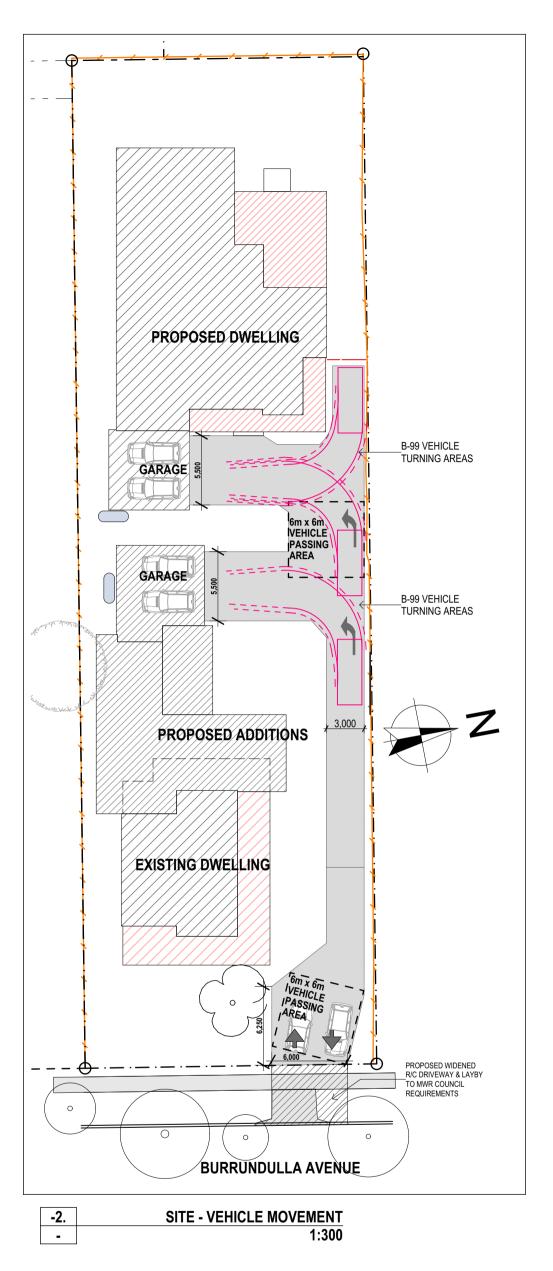

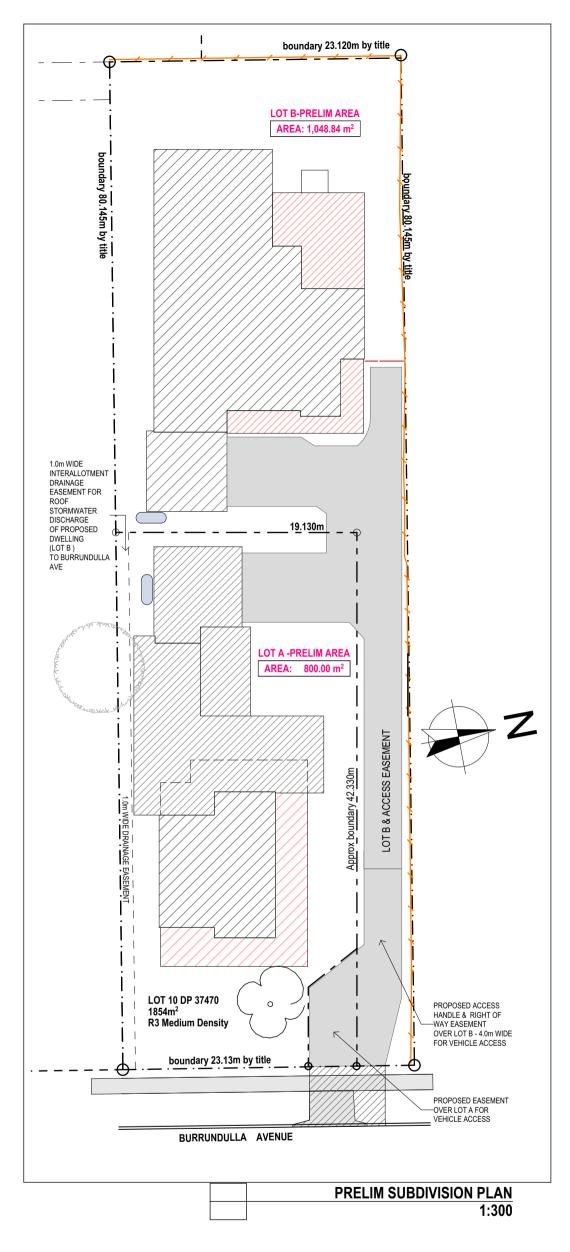

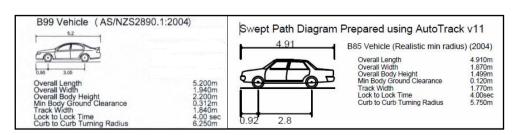

NOTE: Builder to check all dimensions and levels on site prior to construction. builde to drew and interesting and levels of site print to constitution. Notify any errors, discrepancies or omissions to the Designer. Refer to written dimensions only. Do not scale drawings. Drawings shall not be used for construction purposes until issued for construction. This drawing to be used only for the site lot as noted.

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BUILDING CLASSIFICATION: 1a

D.A. DOCUMENTATION В 28.8.21 Α 14.6.21 PRELIMINARY

ISSUE DATE

DESCRIPTION



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ACCREDITED CHARTERED MEMBER OF BUILDING DESIGNERS AUSTRALIA - ACCREDITATION No: 6077

D.P. NUMBER: DP 37470 SITE AREA: 1854m2 DATE: 28.8.21 DRAWN: M Palmer

PROJECT No: 112.21

SCALE: 1:100, 1:250 DRAWING No: 5


**CLIENT:** 3MJ DEVELOPMENTS P/L

**PROJECT:** PROPOSED DUAL OCCUPANCY -ADDITIONS & RENOVATIONS TO EXISTING DWELLING

**SITE ADDRESS:** 

4 BURRUNDULLA AVE MUDGEE


**SHEET DESCRIPTION:** VEHICLE MOVEMENT, PRELIM SITE SUBDIVISION

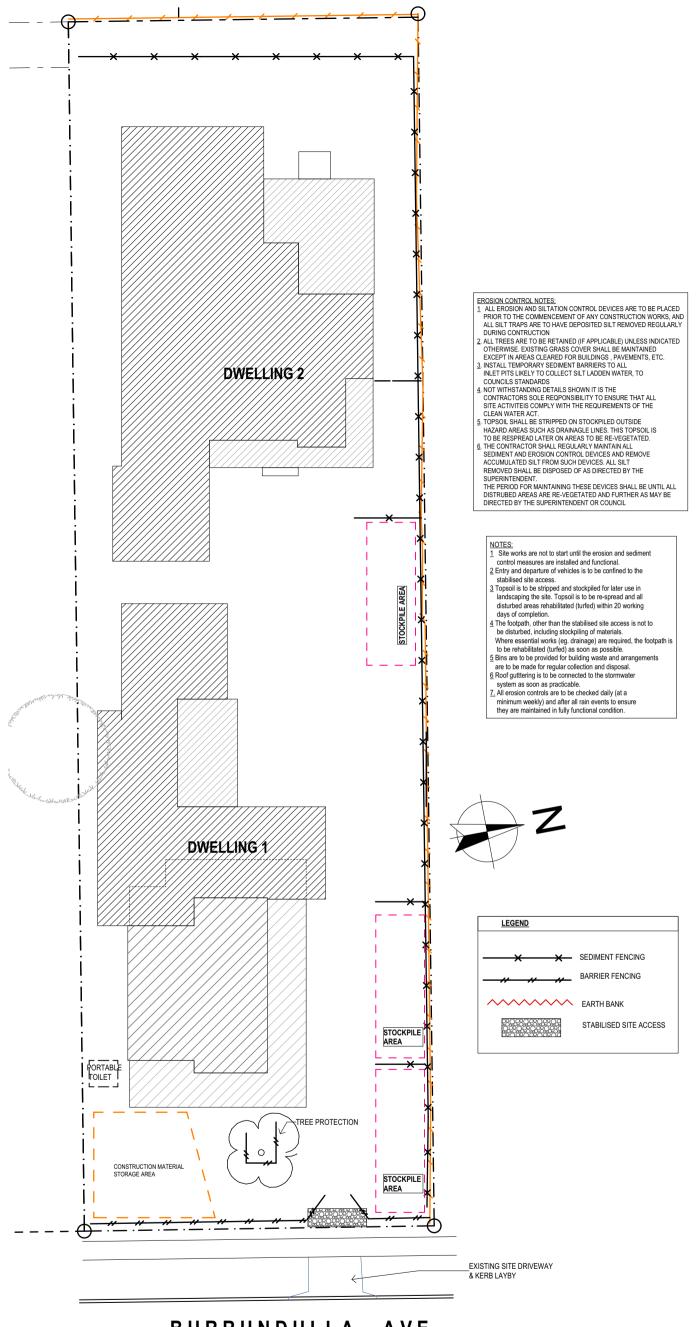


# 1.5 m star pickets at max. 2.5 m centres Direction of flow **Construction Notes** Construct sediment fences as close as possible to being parallel to the contours of the site, but with small returns as shown in the drawing to limit the catchment area of any one section. The catchment area should be small enough to limit water flow if concentrated at one point to 50 litres per second in the design storm event, usually the 10-year event. Cut a 150-mm deep trench along the upslope line of the fence for the bottom of the fabric to be entrenched.

- Join sections of fabric at a support post with a 150-mm overlap
- Backfill the trench over the base of the fabric and compact it thoroughly over the geotextile

#### **SEDIMENT FENCE**

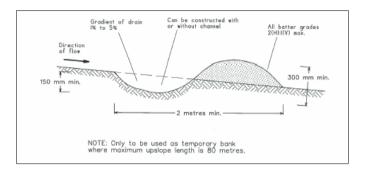

#### **EARTH DIVERSION BANK**

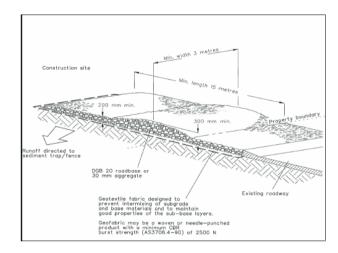

## TEMPORARY CONSTRUCTION ACCESS

#### AVE BURRUNDULLA

-2. **EROSION CONTROL PLAN** 1:250

## DRAWING TO SCALE ON A3 SIZE SHEET FORMAT ONLY

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II

SITE AREA: 1854m2 DATE: 28.8.21 DRAWN: M Palmer SCALE: 1:100, 1:250

D.P. NUMBER: DP 37470

DRAWING No: 6

PROJECT No: 112.21


PROJECT: PROPOSED DUAL OCCUPANCY -ADDITIONS & RENOVATIONS TO EXISTING DWELLING


**CLIENT:** 3MJ DEVELOPMENTS P/L


**SITE ADDRESS:** 

4 BURRUNDULLA AVE MUDGEE

**SHEET DESCRIPTION: EROSION CONTROL PLAN** 

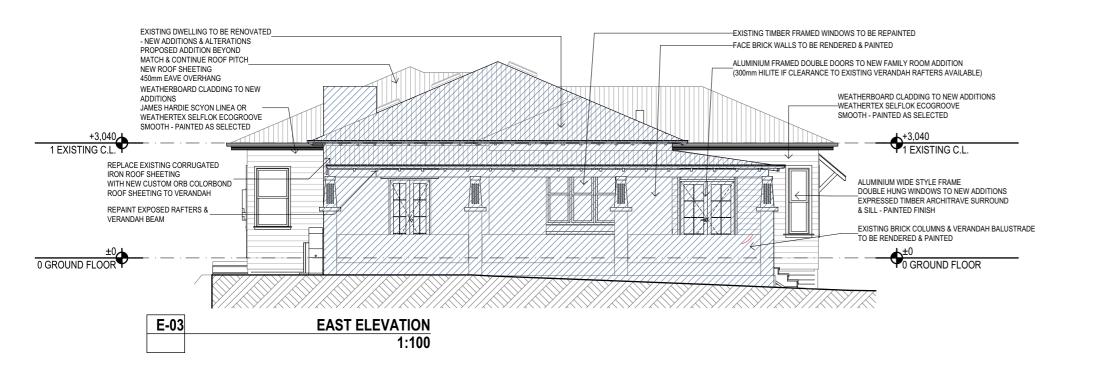

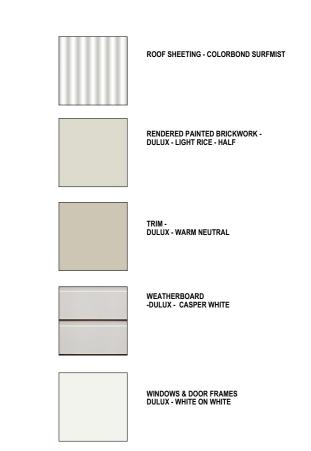

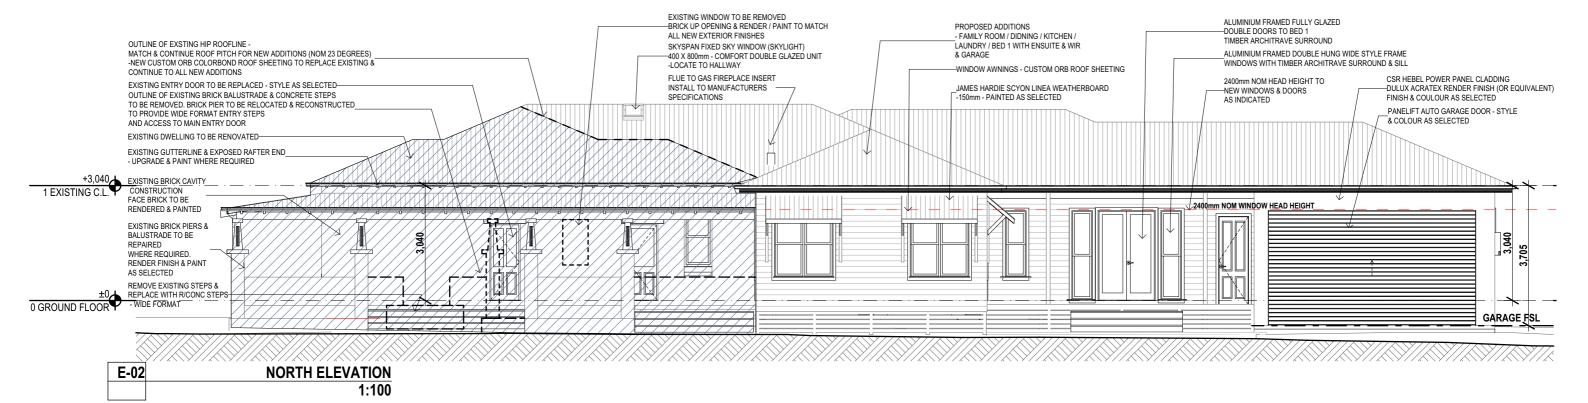

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28.8.21 D.A. DOCUMENTATION

PRELIMINARY

14.6.21

ISSUE DATE DESCRIPTION

**BUILDING CLASSIFICATION:** 



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D.P. NUMBER: DP 37470 SITE AREA: 1854m2 DATE: 14.6.21

DRAWN-M Palmer SCALE: 1:100, 1:250

PROJECT No: 112.21

DRAWING No: 8

**CLIENT:** 3MJ DEVELOPMENTS P/L

PROJECT: PROPOSED DUAL OCCUPANCY -ADDITIONS & RENOVATIONS TO EXISTING DWELLING


SITE ADDRESS:

4 BURRUNDULLA AVE MUDGEE

SHEET DESCRIPTION:

**DWELLING 1 - ELEVATIONS** 



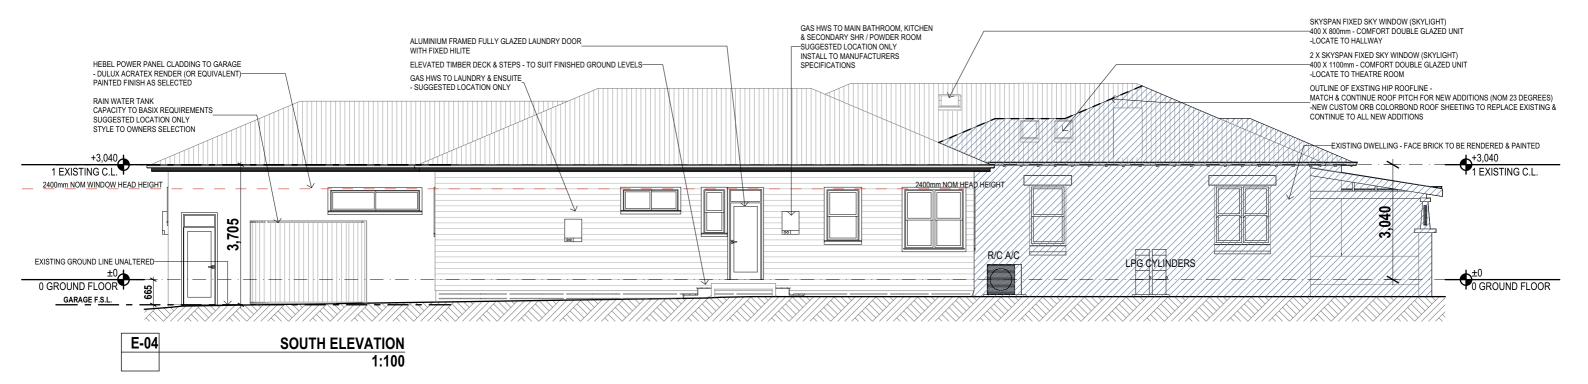

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28.8.21 D.A. DOCUMENTATION 14.6.21 PRELIMINARY ISSUE DATE DESCRIPTION

#### **BUILDING CLASSIFICATION:**



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D.P. NUMBER: DP 37470 SITE AREA: 1854m2 DATE: DRAWN:

14.6.21 M Palmer SCALE: 1:100, 1:250

DRAWING No: 9

PROJECT No: 112.21

**CLIENT:** 3MJ DEVELOPMENTS P/L


PROJECT: PROPOSED DUAL OCCUPANCY -ADDITIONS & RENOVATIONS TO EXISTING DWELLING

**SITE ADDRESS:** 

4 BURRUNDULLA AVE MUDGEE

SHEET DESCRIPTION:

**DWELLING 1 - ELEVATIONS** 

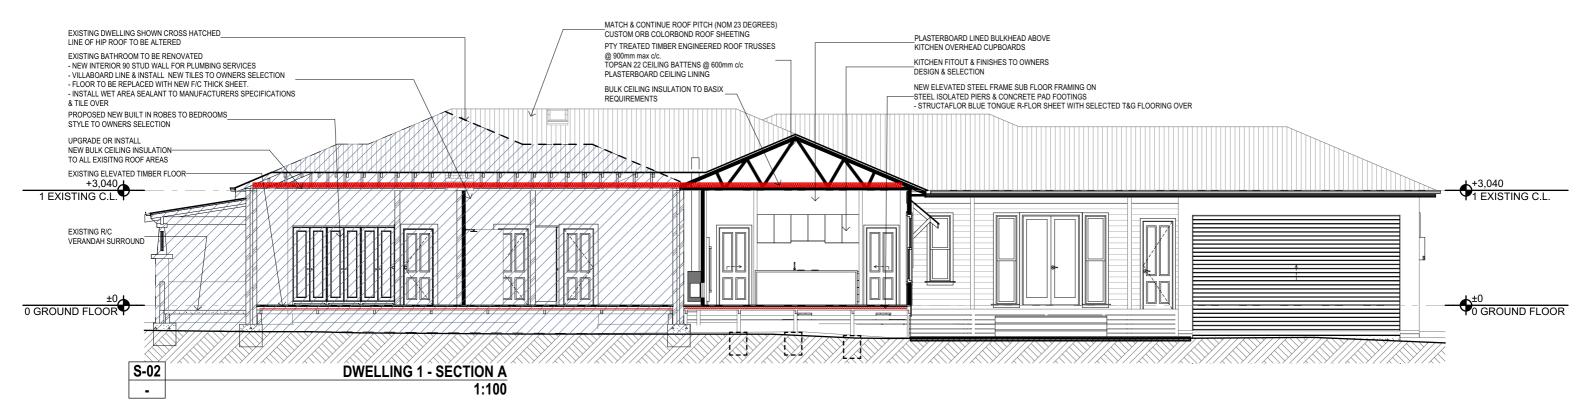

# **BASIX COMMITMENTS**

Fixtures and systems
Hot water
The applicant must install the following hot water system in the development: gas instantaneous.
Lighting
The applicant must ensure a minimum of 40% of new or altered light fixtures are fitted with fluorescent, compact fluorescent, or light-emitting-diode (LED) lamps.
Fixtures
The applicant must ensure new or altered showerheads have a flow rate no greater than 9 litres per minute or a 3 star water rating.
The applicant must ensure new or altered toilets have a flow rate no greater than 4 litres per average flush or a minimum 3 star water rating.
The applicant must ensure new or altered taps have a flow rate no greater than 9 litres per minute or minimum 3 star water rating.

nsulation requirements								
The applicant must construct the new or altered construction (floor(s), walls, and ceilings/roofs) in accordance with the specifications listed in the table below, except that a) additional insulation is not required where the area of new construction is less than 2m2, b) insulation specifie is not required for parts of altered construction where insulation already exists.								
Construction	Additional insulation required (R-value)	Other specifications						
suspended floor with open subfloor: framed (R0.7).	R1.3 (down) (or R2.00 including construction)							
external wall: framed (weatherboard, fibro, metal clad)	R1.30 (or R1.70 including construction)							
internal wall shared with garage: plasterboard (R0.36)	nil							
flat ceiling, pitched roof	ceiling: R2.75 (up), roof: foil/sarking	light (solar absorptance < 0.475)						

28.8.21 D.A. DOCUMENTATION

14.6.21 PRELIMINARY

ISSUE DATE DESCRIPTION

Window / doo	or Orientation	Area of	Overshadowing		Shading device	Frame and glass type		
no.		glass inc. frame (m2)	Height Distance (m) (m)					
W1	E	3.69	0	0	eave/verandah/pergola/balcony >=900 mm	standard aluminium, single pyrolytic low-e, (U-value: 5.7, SHGC: 0.47)		
W2	E	1.08	0	0	eave/verandah/pergola/balcony >=450 mm	standard aluminium, single pyrolytic low-e, (U-value: 5.7, SHGC: 0.47)		
W3	N	2.88	0	0	awning (fixed) >=900 mm	standard aluminium, single pyrolytic low-e, (U-value: 5.7, SHGC: 0.47)		
W4	N	2.88	0	0	awning (fixed) >=900 mm	standard aluminium, single pyrolytic low-e, (U-value: 5.7, SHGC: 0.47)		
W5	W	2.88	0	0	awning (fixed) >=900 mm	standard aluminium, single pyrolytic low-e, (U-value: 5.7, SHGC: 0.47)		
W6	W	2.88	0	0	awning (fixed) >=900 mm	standard aluminium, single pyrolytic low-e (U-value: 5.7, SHGC: 0.47)		
W7	W	7.2	0	0	eave/verandah/pergola/balcony >=900 mm	standard aluminium, single pyrolytic low-e (U-value: 5.7, SHGC: 0.47)		
W8	N	1.08	0	0	eave/verandah/pergola/balcony >=900 mm	standard aluminium, single pyrolytic low-e (U-value: 5.7, SHGC: 0.47)		
W9	N	1.44	0	0	eave/verandah/pergola/balcony >=900 mm	standard aluminium, single pyrolytic low-e (U-value: 5.7, SHGC: 0.47)		
W10	N	3.69	0	0	eave/verandah/pergola/balcony >=900 mm	standard aluminium, single pyrolytic low-e, (U-value: 5.7, SHGC: 0.47)		
W11	N	1.44	0	0	eave/verandah/pergola/balcony >=900 mm	standard aluminium, single pyrolytic low-e, (U-value: 5.7, SHGC: 0.47)		
W12	W	0.72	0	0	eave/verandah/pergola/balcony >=450 mm	standard aluminium, toned/air gap/clear, (U-value: 5.31, SHGC: 0.48)		
W13	s	0.9	0	0	eave/verandah/pergola/balcony >=450 mm	standard aluminium, single pyrolytic low-e, (U-value: 5.7, SHGC: 0.47)		
W14	S	0.72	0	0	eave/verandah/pergola/balcony >=450 mm	standard aluminium, single pyrolytic low-e, (U-value: 5.7, SHGC: 0.47)		
W15	s	1.96	0	0	eave/verandah/pergola/balcony >=450 mm	standard aluminium, single pyrolytic low-e (U-value: 5.7, SHGC: 0.47)		
W16	S	1.26	0	0	eave/verandah/pergola/balcony >=450 mm	standard aluminium, single pyrolytic low-e (U-value: 5.7, SHGC: 0.47)		
W17	S	2.4	0	0	eave/verandah/pergola/balcony >=450 mm	standard aluminium, single pyrolytic low-e, (U-value: 5.7, SHGC: 0.47)		
W18	E	1.44	0	0	eave/verandah/pergola/balcony >=450 mm	standard aluminium, single pyrolytic low-e, (U-value: 5.7, SHGC: 0.47)		

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**BUILDING CLASSIFICATION:** 



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D.P. NUMBER: DP 37470 SITE AREA: 1854m2 DATE: 14.6.21

DRAWN: M Palmer SCALE: 1:100, 1:250

DRAWING No: 10 PROJECT No: 112.21 **CLIENT:** 3MJ DEVELOPMENTS P/L

PROJECT: PROPOSED DUAL OCCUPANCY -ADDITIONS & RENOVATIONS TO EXISTING DWELLING

**SITE ADDRESS:** 

4 BURRUNDULLA AVE MUDGEE

SHEET DESCRIPTION:

DWELLING 1 - SECTION, BASIX COMMITMENTS

#### **General Notes**

ALL WORKS shall be carried out in accordance with the NCC Building Code of Australia, Australian Standards, Local Council equirements, quidelines and all other relevant by laws and authorities. In particular refer Australian standard

-AS 1288 - GLASS IN BUILDINGS - SELECTION & INSTALLATION

-AS 1562 - DESIGN & INSTALLATION OF SHEET ROOF & WALL CLADDING -AS 1684 - RESIDENTIAL TIMBER FRAMED CONSTRUCTION

-AS 2047 - INSTALLATION & SELECTION OF WINDOWS -AS 2870 - RESIDENTIAL SLABS & FOOTINGS

-AS 2904 - DAMP PROOF COURSES AND FLASHINGS -AS 3500 - PLUMBING & DRAINAGE

-AS 3600 - CONCRETE STRUCTURES

-AS 3660 - TERMITE MANAGEMENT

-AS 3740 - WATERPROOFING OF DOMESTIC WET AREAS

-AS 3786 - SMOKE ALARMS

-AS 4055 - WIND LOADING FOR HOUSING -AS 4678 - EARTH RETAINING STRUCTURES

-AS 5146 - REINFORCED AUTOCLAVED AERATED CONCRETE

Drawings shall be read in conjunction with engineers drawings and computations. All structure to Engineers design.

#### DIMENSIONS:

Do not scale off drawings - use figured dimensions only. Contractor shall verify all dimensions on site prior to construction. Any discrepancies or errors shall be referred to the builder and client prior to installation or manufacture of any works. Confirm levels and RL's on site prior to commencement of work.

Contractor to confirm exact siting and orientation prior to construction setout. All building setout and confirmation of setbacks and height to be carried out by a Licensed Surveyor. No footing, or wall to encroach the title boundary.

TERMITE PROTECTION: Termite protection to be in accordance with A.S. 3660.1 and installed in strict accordance with current manufacturers specification

STRUCTURAL STEEL

Unless noted otherwise all exposed structural steel, anchor bolts and other attachments shall be hot dip

galvanised. A cold gal painted finish shall be applied to any field welding to existing or new steelwork. All steel work cast in concrete footings or slab shall have a bitumen finish applied to full extent of cast in concrete steel. Check all dimensions on site prior to

## RETAINING WALLS: SLAB & FOOTINGS:

All retaining walls to pty engineered manufacturers specifications or to structural engineers details. Provide rubble backfill and agg drainage to all retaining walls. Builder to provide tanking if or where required.

All footings to structural engineers details. A moisture barrier shall be installed under any habitable concrete slab to BCA, Australian Standards and manufacturer's requirements

#### ARTICULATION JOINTS:

Provide articulation joints to comply with CSR Hebel Design & Installation Specifications

#### FROSION CONTROLS:

All building works to comply with local authorities Erosion and Sediment control standards.

#### WATERPROOFING:

All wet areas and walls to be waterproofed in accordance with the NCC BCA Part 3.8.1 & AS 3740. Wall finishes shall be impervious to a minimum height of 1800mm above floor level to shower enclosures and minimum 150mm above baths, basins & sinks. Builder to provide certificate of installation and compliance.

#### CONCEALMENT OF SERVICES:

All services shall be concealed in walls or ducts. Where services are exposed they must be

confirmed and approved on site prior to installation unless noted otherwise LICENSED TRADESPERSONS:

All services to be installed by licensed tradespersons in accordance with local authority and with current manufacturers specifications.

## ALL PRODUCTS:

To be installed to manufacturers requirements and to be in accordance with manufacturers requirements for

#### PROPRIETARY ITEMS:

# Identification of a proprietary item does not necessarily imply exclusive preference for the item so identified, but indicates the necessary properties of the item. If alternatives are proposed, confirm selections with owner including

available technical information, reasons for proposed substitutions and cost.

Expansion joints, walls: 5mm. Floors: 8mm. Fill both with silicone rubber. Grout for wall: Epoxy based mildew resistant. Grout for floors: prepared grout to be acid resistant. all wall tiles to have fc substrate

#### Glazing shall be installed to a size,type & thickness to comply with NCC BCA Part 3.6 for Class 1 & 10 buildings within a

design wind speed of not more than N3.

Safety glass to be used in the following cases: i) All rooms - within 500mm vertical of the floor

ii) Bathrooms - within 2000mm of the floor iii) Laundry - within 1200mm vertical from floor and / or within 300mm horizontal from all doors

iv) Doorway - within 300mm horizontal from doors Shower Screens shall be Grade A Safety Glass

#### INTERNAL PAINTING:

Unless noted otherwise paint system to be Dulux approved 3 coat system - low sheen finish. Colours to be supplied by owner during contract and applied as per Dulux's recomendations and guidelines. JOINERY ITEMS SHALL INCLUDE:

Manufactured casework items, including: cabinets and cupboards APPLIANCES & EQUIPMENT:

Builder to co-ordinate all appliance and equipment locations on site and with joiner. Installation and

#### final connection by the contractor. DOCUMENTATION:

The contractor shall carry out works in accordance with the signed drawings and specifications and anything reasonable inferred

and with the Conditions of Contract. The drawings and specifications/schedules shall be considered complementary, and any work and/or materials absent from one but present or implied in the other shall be furnished as if they were present in both

#### **GENERAL NOTES CONTINUED**

#### FIXINGS, TIE DOWN AND BRACING:

The contractor must ensure that all fixings, brackets and the like are compatible materials prior to procurement / installation. All bracing and tie down connections are in accordance with AS1684 and any other relavant codes and

egislation, and to nominated truss & frame manufacturers engineered documentation and specifications. Refer to AS 1684 for the required fixing type as nominated (nominal or specific).

All linings and claddings that are used for bracing purposes need to be fixed according to the

manufacturer's requirements to achieve the nominated bracing requirements

#### EXISTING SITE CONDITIONS:

All existing elements have been shown indicatively. The Contractor shall inspect the site to fully understand the scope of works. Contractors are to inform themselves of existing site conditions and services.

The Contractors Tender amount shall be deemed to include the cost of dealing with existing

conditions and services

The existence of which was ascertainable from the appropriate authority, or from visual inspection on or adjacent to the site; or which are shown on the Drawings or described in the Specification. PRESERVATIVES AND TREATMENT:

All Structural timbers to be treated with suitable preservatives and to an appropriate hazard level for their intended environment which will meet the required design life expectancy of 50 years.

FINAL CERTIFICATE:

At completion of work, Builder to obtain and supply an Occupation Certificate from Principal Certifying Authority.

#### Excavation Notes

#### FOOTING EXCAVATION:

Ensure building is correctly set-out prior to excavation. All earthworks in accordnce with NCC BCA Part 3.1.1

#### EXTENT:

Excavation and cut & fill as noted on the Architectural Drawings for Proposed Dwelling. Site cut & levels indicated are preliminary only and to be checked on site before work commencement. Retaining walls required.

#### SITE SURFACE:

Excavate over the site to give correct levels and profiles as the basis for construction, paving, filling, landscaping and the like. Make allowance for compaction and settlement

Grade to minimum falls of 1:20 away from buildings within 1200 of building perimeter and 1:100 elsewhere unless noted otherwise. Negate surface water discharging on to neighbouring properties

#### REQUIREMENT OF DETAILED EXCAVATION:

Excavate to the Contract depths and extent necessary to accompdate all foundation elements and any formwork, blinding concrete, working spaces and waterproofing processes

Landscaping scope of works and finishes to be confirmed by client prior to final quotation

Trim bottom of all excavations as necessary to attain the required levels, grades and profiles of the finished work

In accordance with NCC BCA Part 3.1.

#### Hydraulic Notes

ALL WORKS shall be carried out in accordance with the following requirements

- The Plumbing and Drainage Act 2002 - AS 3500 - 2003
- The Local Authority
- Any other authority have jurisdiction over any part of the works.
   All subterranean services to be located prior to construction.

#### **EXISTING SITE CONDITIONS:**

The Contractor shall attend to existing services. Contractors are to inform themselves of existing site conditions and plumbing services before work commencen

Design Levels shall be confirmed on site, prior to commencing installation of any pipework. Levels shown on drawings are recomended only. It shall be the Contractors responsibility to ensure

that correct grades are attained at site.

RAINWATER DRAINAGE: Allow to connect all new rainwater drainage downpipes etc., to the existing stormwater drainage system.

RAINWATER GOODS:

Refer to documentation for specification and finish.
Unless otherwise noted: new roofing sheeting, ridge cappings and valley flashings shall be metal with a colorbond finish. downpipes to be metal colorbond (min 0.5mm guage).
Unless otherwise noted: new gutters, gutter spikes, barge rolls; new metal wall cladding;

associated flashings and cappings shall be metal with any "colorbond" finish nominated

#### MATERIAL S.

Water services shall be in accordance with Australian Standards. COVER PLATES:

#### Provide Cover Plates at all wall & floor penetrations.

SANITARY PLUMBING: Sanitary plumbing shall be UPVC Class HD with solvent weld joints and shall be laid at a minimum grade of 1:60 unless noted otherwise. Connect sanitary plumbing to council sewer

in accordance with authority requirements. INSULATION:

All hot water lines shall be fully insulated.

DIAL BEFORE YOU DIG:
It is the contractors responsibility to contact "Dial Before You Dig" Phone 1100 for the

location of existing public utilities prior to excavation

ENCASING OF UNDERGROUND SERVICES: All underground water and fire services shall be encased in 100mm of sand

## Hydraulic Notes

#### AUTHORITIES FEES AND CHARGES:

The Contractor shall allow to pay all authorities fees & charges associated with new connections

To provide necessary flashings to windows and openings. Plumbing to be carried by a licenced plumber and in accordance

with the requirement of local authorities. The contractor shall be responsable for all permits and approvals. All hot water lines shall be fully

insulated. Sanitary Plumbing shall be connected to existing system with materials approved by the local authority. Builder and Sub-contractor to ensure all stormwater drains and sewer pipes are located at sufficient distance from any building footings and/or slab edge beams to prevent moisture penetration, dampness, weakening or undermining

#### HOT WATER SUPPLY:

All domestic hot water to basins, showers and baths to have maximum temperature of 50°C. Allow to supply and

install tempering valves where required, as nominated in the NCC BCA and relevant standards

#### Electrical Notes

SUPPLY: Electrical contractor to provide phased supply to main switchboard and assess maximum demand to AS3000

DISTRIBUTION BOARD: Provide new distribution board if required. All electrical outlets shall be protected by overcurrent/earth leakage circuit breakers in accordance with Australian Standards. WIRING: Electrical conductors and wiring used for electrical services shall be in accordance with NCC BCA and Australian standards. All wiring shall be concealed where possible. Where exposed wiring is unavoidable, wiring must be concealed within suitable conduit. ARTIFICIAL LIGHTING: Provide a system of artificial lighting to comply with AS1680

to all rooms not naturally lit. LIGHTING: All luminaires shall be ceiling mounted unless otherwise required by owner.

If provided, refer to the schematic electrical plan for mounting heights of exterior wall mounted luminaires and layout of luminaires as indicated on reflected ceiling drawing. All flourescent

lamps shall be cool white unless requested otherwise FINAL LOCATIONS: If provided, refer to drawings for specific locations of accessories.

- ELECTRICAL INSTALLATION: includes: installation of distribution switchboard (if required)
- light and power installation
- light fittings, sub circuit wiring and lighting accessories
- socket outlets, special purpose power and subcircuit cabling
- installation of ciruits for air conditioning installation of circuits and connection of all equipment (eg kitchen equipment)

- supply and installation of new outlet + wiring to roof mounted tv antenna.

ELECTRICAL ACCESSORIES: includes: switches and powerpoints. unless otherwise noted

all controls, switches and powerpoints shall be "pure white ". light switches - 1200 above floor level unless noted otherwise and located s ner electrical lavouts

ROOFTOP ANTENNA: All new relevant outlets to be wired to antenna. NETWORK & DATA: All phone networks and data points to be min cat6 cable

connected to wall sockets. Cable runs to be concealed. If provided refer to electrical layouts for locations SWITCHES: Some light switches may require dimmers. Confirm with client prior to final quotation

# Joinery Notes

JOINERY ITEMS SHALL INCLUDE: Manufactured casework items, including: cabinets and cupboards.

APPLIANCES & EQUIPMENT: Builder to co-ordinate all appliance and equipment locations on site

Installation and final connection by the contractor. Joiner to confirm all appliance and equipment tolerances and requirements in joinery prior to fabrication.

SITE MEASURE: All joinery to be site measured once linings are in place

Confirm any discrepencies prior to fabrication.

# Fire Safety

GENERAL: Fire safety in accordance with part 3.7 of the NCC BCA SMOKE ALARMS: In accordance with part 3.7.5 of the BCA & A.S 3786 to be hard wired to consumer supply.Smoke dectors to be of the

type with alarms wired together and having a battery back-up FIRE ALARM INSTALLATION: Install smoke detection, in the area affected by the works, to suit the requirements of AS1670 and the

BCA. Provide any additional detection to areas to allow for compliance with AS1670 and the BUILDER: To provide electricians installation certificate

# **Energy Efficiency**

WORKS: In accordance with BCA Environmental guidelines. LUMINAIRES: All lamps to luminaires shall be energy efficient lamps to suit specific luminaire EXTERNAL WALL: In accordance with BCA Environmental guidelines. Installed as per manufacturers instructions. All external walls to have

vapour permeable sarking

Weatherproof seals to all external doors. NEW ROOF: In accordance with NCC BCA Environmental guidelines. Installed as per manufacturers instructions. TIMBER FLOORS: (Where applicable) In accordance with NCC BCA Environmental guidelines

Installed as ner manufacturers instructions All exposed timber floors to have required insulation to underside as per Basix Certificate .

LIGHT & VENTILATION: In accordance with parts 3.8.4 and 3.8.5 of the NCC BCA plus relevant A.S. SOUND: Insulation in accordance with part 3.8.6 of the NCC BCA

# 450mm EAVE OVERHANG TO NEW ADDITIONS DECORATIVE FEATURE AWNINGS OVER WINDOWS TO FAMILY ROOM OUTLINE OF EXISTING ENCLOSED SKILLION TO BE REMOVED VELUX DOUBLE EXISTING HIP ROOFLINE GLAZED LOW E SKYLIGHTS TO BE ALTERED FOR TO THEATRE ROOM NEW ADDITION MATCH & CONTINUE -ROOF PITCH (NOM 23 DEGREES) NEW CUSTOM ORB COLORBOND ROOF SHEETING COLOUR AS SELECTED **ROOF AREA** AREA: 398.54 m<sup>2</sup>

**DWELLING 1 - ROOF PLAN** 1.

#### DRAWING TO SCALE ON A3 SIZE SHEET FORMAT ONLY

Builder to check all dimensions and levels on site prior to construction. Notify any errors, discrepancies or omissions to the Designer. Refer to written dimensions only. Do not scale drawings. Drawings shall not be used for construction purposes until issued for construction. This drawing to be used only for the site lot as noted.

All boundaries and contours are subject to survey. All levels to AHD. It is the contractors responsibility to confirm all measurements on site and locations of any services prior to work on site

All documents are subject to Australian Copyright Law

28.8.21 D.A. DOCUMENTATION 14.6.21 PRELIMINARY

BUILDING CLASSIFICATION:



#### Preferred Design & Drafting 30 Lewis Street

Mudgee NSW 2850 ph: 0263724397 Mob: 0429600160

II

D.P. NUMBER: DP 37470 SITE AREA: 1854m2 14.6.21 M Palmer

SCALE: 1:100, 1:250

**CLIENT:** 3MJ DEVELOPMENTS P/L

PROJECT: PROPOSED DUAL OCCUPANCY -ADDITIONS & RENOVATIONS TO EXISTING DWELLING

# SITE ADDRESS:

4 BURRUNDULLA AVE MUDGEE


SHEET DESCRIPTION: DWELLING 1 - ROOF PLAN, GENERAL NOTES


ISSUE DATE DESCRIPTION

ACCREDITED CHARTERED MEMBER OF BUILDING DESIGNERS AUSTRALIA

DATE: DRAWN-

> DRAWING No: 11 PROJECT No: 112.21

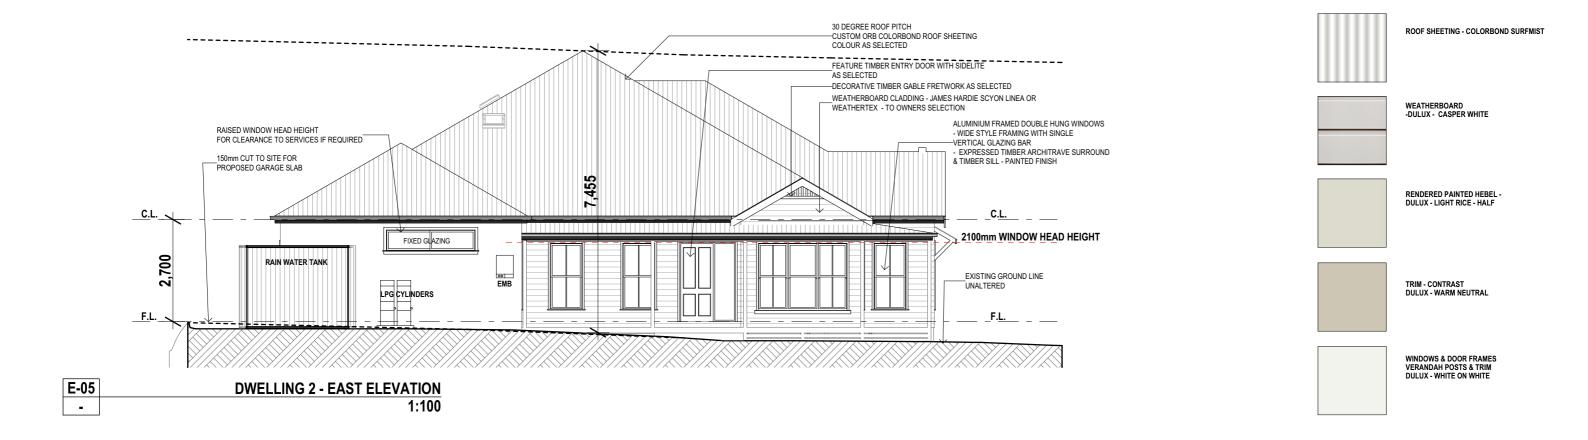

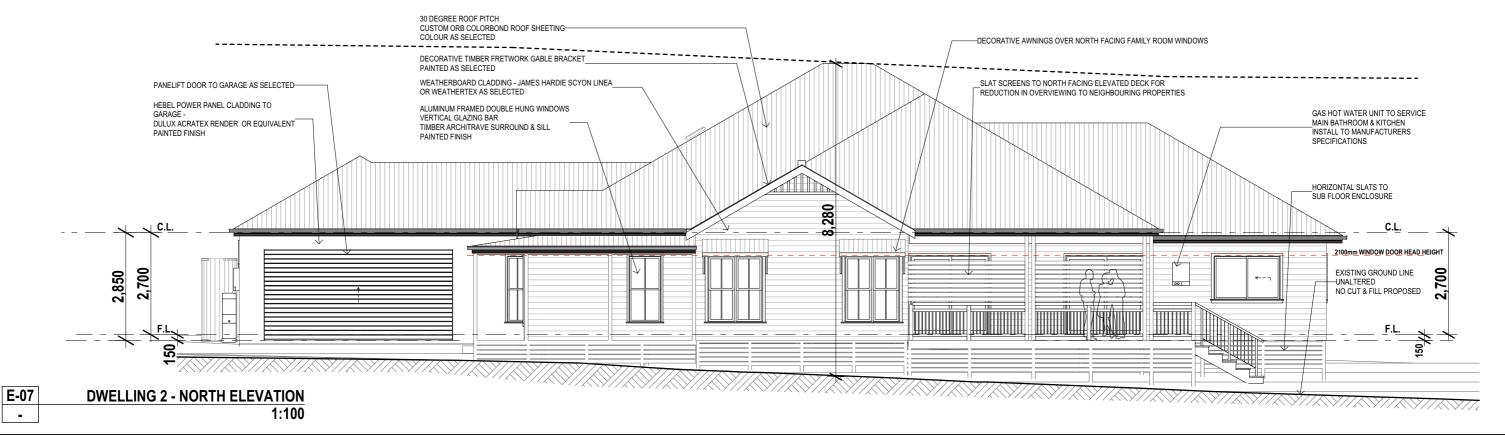

NOTE:
Builder to check all dimensions and levels on site prior to construction.
Notify any errors, discrepancies or omissions to the Designer. Refer to written dimensions only. Do not scale drawings. Drawings shall not be used for construction purposes until issued for construction. This drawing to be used only for the site lot as noted.

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to be used only for the site lot as noted.

All boundaries and contours are subject to survey. All levels to AHD.

It is the contractors responsibility to confirm all measurements on site and locations of any services prior to work on site

B 28.8.21 D.A. DOCUMENTATION
A 14.6.21 PRELIMINARY

ISSUE DATE DESCRIPTION

#### **BUILDING CLASSIFICATION:**



# Preferred Design & Drafting

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SCALE: 1:100, 1:250

DRAWING No: 13

PROJECT No: 112.21

D.P. NUMBER: DP 37470

1854m2

14.6.21

M Palmer

SITE AREA:

DATE:

DRAWN-

CLIENT: 3MJ DEVELOPMENTS P/L


**PROJECT:** PROPOSED DUAL OCCUPANCY - ADDITIONS & RENOVATIONS TO EXISTING DWELLING


SITE ADDRESS:

4 BURRUNDULLA AVE MUDGEE

SHEET DESCRIPTION:

DWELLING 2 - ELEVATIONS

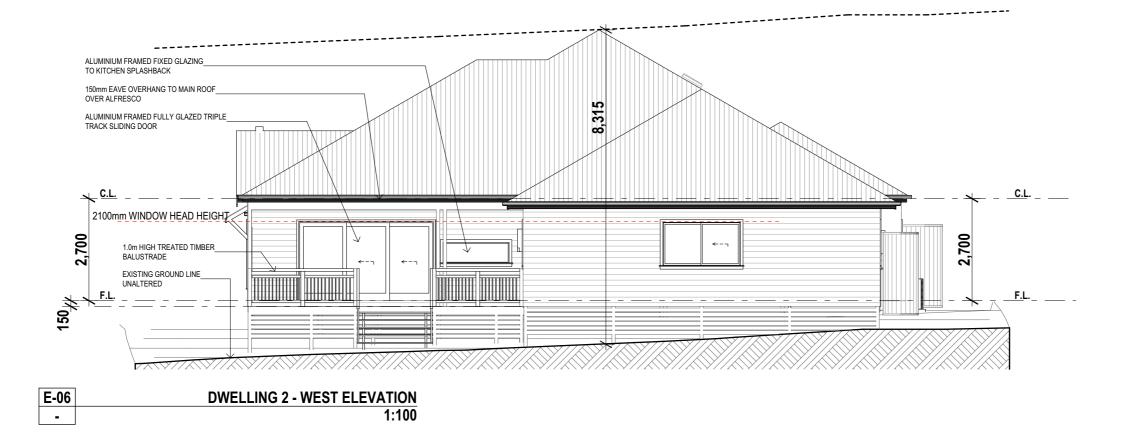

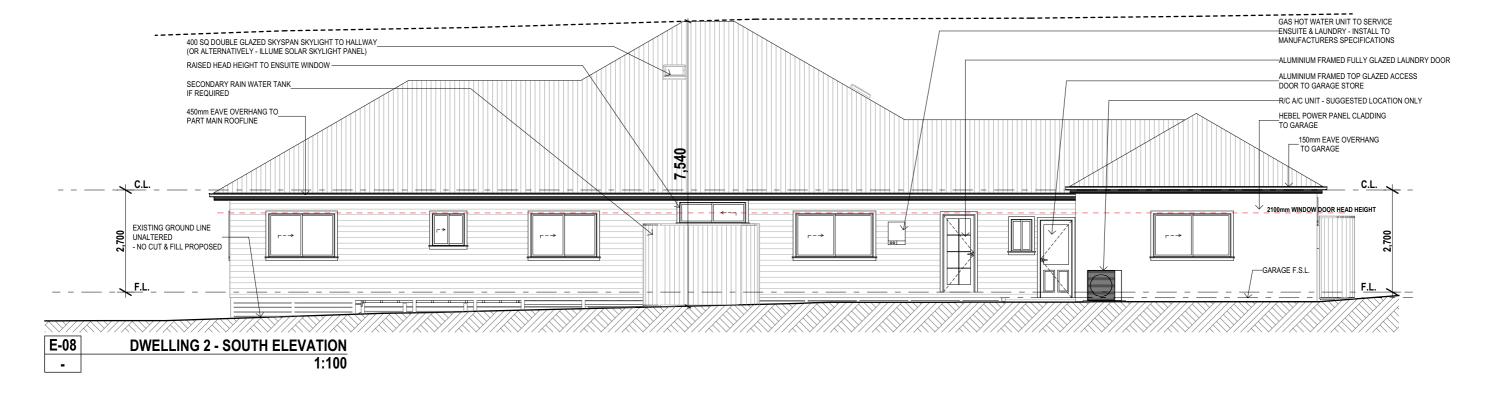

NOTE:
Builder to check all dimensions and levels on site prior to construction. Notify any errors, discrepancies or omissions to the Designer. Refer to written dimensions only. Do not scale drawings. Drawings shall not be used for construction purposes until issued for construction. This drawing to be used only for the site lot as noted.

All boundaries and contours are subject to survey. All levels to AHD. It is the contractors responsibility to confirm all measurements on site and locations of any services prior to work on site

All documents are subject to Australian Copyright Law.

**BUILDING CLASSIFICATION:** 

28.8.21 D.A. DOCUMENTATION

14.6.21 PRELIMINARY

ISSUE DATE DESCRIPTION



## **Preferred Design** & Drafting

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ACCREDITED CHARTERED MEMBER OF BUILDING DESIGNERS AUSTRALIA - ACCREDITATION No: 6077

D.P. NUMBER: DP 37470 SITE AREA: 1854m2 DATE: 14.6.21

DRAWN: M Palmer SCALE: 1:100, 1:250

DRAWING No: 14 PROJECT No: 112.21 **CLIENT:** 3MJ DEVELOPMENTS P/L

PROJECT: PROPOSED DUAL OCCUPANCY -ADDITIONS & RENOVATIONS TO EXISTING DWELLING

**SITE ADDRESS:** 

4 BURRUNDULLA AVE MUDGEE

SHEET DESCRIPTION:

**DWELLING 2 - ELEVATIONS** 



#### **BASIX COMMITMENTS**

Construction	Additional insulation required (R-Value)	Other specifications		
floor - suspended floor above open subfloor, framed	1.3 (or 2 including construction) (down)			
external wall - framed (weatherboard, fibre cement, metal clad)	2.20 (or 2.60 including construction)			
internal wall shared with garage - plasterboard	nil			
ceiling and roof - flat ceiling / pitched roof	ceiling: 4.75 (up), roof: foil/sarking	unventilated; light (solar absorptance < 0.475)		
ceiling and roof - raked ceiling / pitched or skillion roof, framed	ceiling: 4.76 (up), roof: foil/sarking	framed; light (solar absorptance < 0.475)		

Water Commitments
Fixtures
The applicant must install showerheads with a minimum rating of 4 star (> 6 but <= 7.5 L/min plus spray force and/or coverage tests) in all showers in the development.
The applicant must install a toilet flushing system with a minimum rating of 4 star in each toilet in the development.
The applicant must install taps with a minimum rating of 4 star in the kitchen in the development.
The applicant must install basin taps with a minimum rating of 4 star in each bathroom in the development.
Alternative water
Rainwater tank
The applicant must install a rainwater tank of at least 5000 litres on the site. This rainwater tank must meet, and be installed in accordance with, the requirements of all applicable regulatory authorities.
The applicant must configure the rainwater tank to collect rain runoff from at least 406.97 square metres of the roof area of the development (excluding the area of the roof which drains to any stormwater tank or private dam).
The applicant must connect the rainwater tank to:
all toilets in the development

at least one outdoor tap in the development (Note: NSW Health does not recommend that rainwater be used for human

Energy Commitments
Hot water
The applicant must install the following hot water system in the development, or a system with a higher energy rating: gas instantaneous with a performance of 5 stars.
Cooling system
The applicant must install the following cooling system, or a system with a higher energy rating, in at least 1 living area: 1-phase airconditioning; Energy rating: 5 star (cold zone)
The applicant must install the following cooling system, or a system with a higher energy rating, in at least 1 bedroom: 1-phase airconditioning; Energy rating: 5 star (cold zone)
The cooling system must provide for day/night zoning between living areas and bedrooms.
Heating system
The applicant must install the following heating system, or a system with a higher energy rating, in at least 1 living area: 1-phase airconditioning; Energy rating: 5 star (cold zone)
The applicant must install the following heating system, or a system with a higher energy rating, in at least 1 bedroom: 1-phase airconditioning; Energy rating: 5 star (cold zone)
The heating system must provide for day/night zoning between living areas and bedrooms.
Ventilation
The applicant must install the following exhaust systems in the development:
At least 1 Bathroom: individual fan, ducted to façade or roof; Operation control: manual switch on/off
Kitchen: individual fan, ducted to façade or roof; Operation control: manual switch on/off
Laundry: individual fan, ducted to façade or roof; Operation control: manual switch on/off
Artificial lighting
The applicant must ensure that the "primary type of artificial lighting" is fluorescent or light emitting diode (LED) lighting in each of th following rooms, and where the word "dedicated" appears, the fittings for those lights must only be capable of accepting fluorescent light emitting diode (LED) lamps:
at least 4 of the bedrooms / study;
at least 2 of the living / dining rooms;
• the kitchen;
all bathrooms/toilets;
the laundry;
all hallways;
Natural lighting
The applicant must install a window and/or skylight in the kitchen of the dwelling for natural lighting.
The applicant must install a window and/or skylight in 3 bathroom(s)/toilet(s) in the development for natural lighting.
Other
Other  The applicant must install a gas cooktop & electric oven in the kitchen of the dwelling.

Skylight no.	Maximum area metres)	(square	Туре			Shading device				
S01	0.16		alum	inium, moulded plastic single clear		no shading				
S02	0.16		alum	inium, moulded plastic single clear	no shading					
Window/glazed door	no. Maximum height (mm)	Maximum v	vidth	Туре	Shading Devi	ce (Dimension within	Overshadowing			
North facing										
W01	1800	600		U-value: 5.4, SHGC: 0.522 - 0.638 (aluminium, single, Hi-Tsol Low-e)	base of window	mm, 1725 mm above v or glazed door	not overshadowed			
W02	1800	900		U-value: 5.4, SHGC: 0.522 - 0.638 (aluminium, single, Hi-Tsol Low-e)	verandah 1900 base of window	mm, 1725 mm above w or glazed door	not overshadowed			
W03	1800	1500		U-value: 5.4, SHGC: 0.522 - 0.638 (aluminium, single, Hi-Tsol Low-e)		750 mm, 1500 mm window or glazed	not overshadowed			
W04	1800	1500		U-value: 5.4, SHGC: 0.522 - 0.638 (aluminium, single, Hi-Tsol Low-e)		750 mm, 1500 mm window or glazed	not overshadowed			
W05	2100	2100		U-value: 5.4, SHGC: 0.522 - 0.638 (aluminium, single, Hi-Tsol Low-e)	eave 5000 mm of window or g	n, 530 mm above head lazed door	not overshadowed			
W06	2100	2100		U-value: 5.4, SHGC: 0.522 - 0.638 (aluminium, single, Hi-Tsol Low-e)	eave 7300 mm of window or g	n, 530 mm above head lazed door	not overshadowed			
W07	1200	1800		U-value: 5.4, SHGC: 0.522 - 0.638 (aluminium, single, Hi-Tsol Low-e)	eave 550 mm, of window or g	360 mm above head lazed door	not overshadowed			
East facing										
W08	1800	900		U-value: 5.4, SHGC: 0.522 - 0.638 (aluminium, single, Hi-Tsol Low-e)	verandah 1900 mm, 1725 mm above base of window or glazed door		not overshadowed			
W09	1800	900		U-value: 5.4, SHGC: 0.522 - 0.638 (aluminium, single, Hi-Tsol Low-e)	verandah 1900 mm, 1725 mm above base of window or glazed door		not overshadowed			
W10	2100	1500		timber/UPVC/fibreglass, single, clear	verandah 1900 mm, 2065 mm above base of window or glazed door		not overshadowed			
W11	1800	2400		U-value: 5.4, SHGC: 0.522 - 0.638 (aluminium, single, Hi-Tsol Low-e)	verandah 1900 mm, 1725 mm above base of window or glazed door		not overshadowed			
W12	1800	900		U-value: 5.4, SHGC: 0.522 - 0.638 (aluminium, single, Hi-Tsol Low-e)	verandah 1900 mm, 1725 mm above base of window or glazed door		not overshadowed			
South facing										
W13	2100	820		aluminium, single, clear	eave 550 mm, 360 mm above head of window or glazed door		not overshadowed			
W14	1200	2100		aluminium, single, clear	eave 550 mm, of window or g	360 mm above head lazed door	not overshadowed			
W15	600	1800		aluminium, single, clear	eave 550 mm, of window or g	360 mm above head lazed door	not overshadowed			
W16	1200	1800		aluminium, single, clear	eave 550 mm, of window or g	360 mm above head lazed door	not overshadowed			
W17	900	900		aluminium, single, clear	eave 550 mm, of window or g	360 mm above head lazed door	not overshadowed			
W18	1200	1800		aluminium, single, clear	eave 550 mm, 360 mm above head of window or glazed door		not overshadowed			
West facing										
W19	2100	3600		U-value: 5.4, SHGC: 0.522 - 0.638 (aluminium, single, Hi-Tsol Low-e)	eave 7700 mm, 365 mm above head of window or glazed door		not overshadowed			
W20	600	1800		aluminium, single, clear	eave 3200 mm, 1200 mm above head of window or glazed door		not overshadowed			
W21	1200	2100		aluminium, single, clear	eave 550 mm, of window or g	365 mm above head lazed door	not overshadowed			

#### DRAWING TO SCALE ON A3 SIZE SHEET FORMAT ONLY

consumption in areas with potable water supply.)

Builder to check all dimensions and levels on site prior to construction. Notify any errors, discrepancies or omissions to the Designer. Refer to written dimensions only. Do not scale drawings. Drawings shall not be used for construction purposes until issued for construction. This drawing to be used only for the site lot as noted.

All boundaries and contours are subject to survey. All levels to AHD. It is the contractors responsibility to confirm all measurements on site and locations of any services prior to work on site All documents are subject to Australian Copyright Law.

28.8.21 D.A. DOCUMENTATION 14.6.21 PRELIMINARY

ISSUE DATE DESCRIPTION

**BUILDING CLASSIFICATION:** 



#### **Preferred Design** & Drafting

Mudgee NSW 2850 ph: 0263724397 Mob: 0429600160 email: marian@preferred-design.com.au

30 Lewis Street

ACCREDITED CHARTERED MEMBER OF BUILDING DESIGNERS AUSTRALIA

D.P. NUMBER: DP 37470 SITE AREA: 1854m2 14.6.21

DATE: DRAWN: M Palmer

SCALE: 1:100, 1:250 DRAWING No: 15

PROJECT No: 112.21

**CLIENT:** 3MJ DEVELOPMENTS P/L

**PROJECT:** PROPOSED DUAL OCCUPANCY -ADDITIONS & RENOVATIONS TO EXISTING DWELLING

**SITE ADDRESS:** 

4 BURRUNDULLA AVE MUDGEE

**SHEET DESCRIPTION:** 

DWELLING 2 - SECTION, BASIX COMMITMENTS

#### **General Notes**

ALL WORKS shall be carried out in accordance with the NCC Building Code of Australia, Australian Standards, Local Council requirements, quidelines and all other relevant by laws and authorities. In particular refer Australian standards

- -AS 1288 GLASS IN BUILDINGS SELECTION & INSTALLATION
- -AS 1562 DESIGN & INSTALLATION OF SHEET ROOF & WALL CLADDING -AS 1684 RESIDENTIAL TIMBER FRAMED CONSTRUCTION
- -AS 2047 INSTALLATION & SELECTION OF WINDOWS
- -AS 2870 RESIDENTIAL SLABS & FOOTINGS
- -AS 2904 DAMP PROOF COURSES AND FLASHINGS
- -AS 3500 PLUMBING & DRAINAGE
- -AS 3600 CONCRETE STRUCTURES
- -AS 3660 TERMITE MANAGEMENT
- -AS 3740 WATERPROOFING OF DOMESTIC WET AREAS
- -AS 3786 SMOKE ALARMS -AS 4055 - WIND LOADING FOR HOUSING
- -AS 4678 EARTH RETAINING STRUCTURES
- -AS 5146 REINFORCED AUTOCLAVED AERATED CONCRETE

Drawings shall be read in conjunction with engineers drawings and computations. All structure to Engineers design. All drawings to be co-ordinated with consultant documentation prior to construction.

#### DIMENSIONS:

Do not scale off drawings - use figured dimensions only. Contractor shall verify all dimensions on site prior to

construction. Any discrepancies or errors shall be referred to the builder and client prior to installation or manufacture of any works. Confirm levels and RL's on site prior to commencement of work.

Contractor to confirm exact siting and orientation prior to construction setout. All building setout and confirmation of setbacks and height to be carried out by a Licensed Surveyor. No footing, or wall to encroach the title boundary. TERMITE PROTECTION:

Termite protection to be in accordance with A.S. 3660.1 and installed in strict accordance with current manufacturers specifications

Unless noted otherwise all exposed structural steel, anchor bolts and other attachments shall be hot dip

galvanised. A cold gal painted finish shall be applied to any field welding to existing or new steelwork. All steel work cast in concrete ootings or slab shall have a bitumen finish applied to full extent of cast in concrete steel. Check all dimensions on site prior to

All retaining walls to pty engineered manufacturers specifications or to structural engineers details. Provide rubble backfill and nage to all retaining walls. Builder to provide tanking if or where required.

#### SLAB & FOOTINGS:

All footings to structural engineers details. A moisture barrier shall be installed under any habitable concrete slab to BCA, Australian Standards and manufacturer's requirements

#### ARTICULATION JOINTS:

Provide articulation joints to comply with CSR Hebel Design & Installation Specifications

#### EROSION CONTROLS:

All building works to comply with local authorities Erosion and Sediment control standards.

All wet areas and walls to be waterproofed in accordance with the NCC BCA Part 3.8.1 & AS 3740. Wall finishes shall be

impervious to a minimum height of 1800mm above floor level to shower enclosures and minimum 150mm above baths,

basins & sinks. Builder to provide certificate of installation and compliance.

#### CONCEALMENT OF SERVICES:

All services shall be concealed in walls or ducts. Where services are exposed they must be

## confirmed and approved on site prior to installation unless noted otherwise LICENSED TRADESPERSONS:

All services to be installed by licensed tradespersons in accordance with local authority and with current

#### manufacturers specifications. ALL PRODUCTS:

To be installed to manufacturers requirements and to be in accordance with manufacturers requirements for

Identification of a proprietary item does not necessarily imply exclusive preference for the item so identified,

but indicates the necessary properties of the item. If alternatives are proposed, confirm selections with owner including

Expansion joints, walls: 5mm. Floors: 8mm. Fill both with silicone rubber. Grout for wall: Epoxy based mildew resistant. Grout for floors: prepared grout to be acid resistant. all wall tiles to have fc substrate.

Glazing shall be installed to a size,type & thickness to comply with NCC BCA Part 3.6 for Class 1 & 10 buildings within a

speed of not more than N3.

#### Safety glass to be used in the following cases

i) All rooms - within 500mm vertical of the floor

ii) Bathrooms - within 2000mm of the floor iii) Laundry - within 1200mm vertical from floor and / or within 300mm horizontal from all doors

iv) Doorway - within 300mm horizontal from doors Shower Screens shall be Grade A Safety Glass

#### INTERNAL PAINTING:

Unless noted otherwise paint system to be Dulux approved 3 coat system - low sheen finish. Colours to be

supplied by owner during contract and applied as per Dulux's recomendations and guidelines. JOINERY ITEMS SHALL INCLUDE:

#### APPLIANCES & EQUIPMENT:

Builder to co-ordinate all appliance and equipment locations on site and with joiner. Installation and

#### final connection by the contractor.

### DOCUMENTATION:

The contractor shall carry out works in accordance with the signed drawings and specifications and anything reasonable inferred

and with the Conditions of Contract. The drawings and specifications/schedules shall be considered complementary, and any work and/or materials absent from one but present or implied in the other shall be furnished

#### **GENERAL NOTES CONTINUED**

#### FIXINGS. TIE DOWN AND BRACING:

The contractor must ensure that all fixings, brackets and the like are compatible materials prior to procurement / installation. All bracing and tie down connections are in accordance with AS1684 and

egislation, and to nominated truss & frame manufacturers engineered documentation and specifications. Refer to AS1684 for the required fixing type as nominated (nominal or specific).

All linings and claddings that are used for bracing purposes need to be fixed according to the manufacturer's requirements to achieve the nominated bracing requirements

All existing elements have been shown indicatively. The Contractor shall inspect the site to fully understand the scope of works. Contractors are to inform themselves of existing site conditions

The Contractors Tender amount shall be deemed to include the cost of dealing with existing

conditions and services.

The existence of which was ascertainable from the appropriate authority, or from visual inspection

on or adjacent to the site; or which are shown on the Drawings or described in the Specification PRESERVATIVES AND TREATMENT:

All Structural timbers to be treated with suitable preservatives and to an appropriate hazard level for their intended environment which will meet the required design life expectancy of 50 years. FINAL CERTIFICATE:

At completion of work, Builder to obtain and supply an Occupation Certificate from Principal Certifying Authority.

#### Excavation Notes

#### FOOTING EXCAVATION:

Ensure building is correctly set-out prior to excavation. All earthworks in accordnce with NCC BCA Part 3.1.1 EXTENT:

Excavation and cut & fill as noted on the Architectural Drawings for Proposed Dwelling. Site cut & levels indicated are preliminary only and to be checked on site before work commencement. Retaining walls required.

#### SITE SURFACE:

Excavate over the site to give correct levels and profiles as the basis for construction, paving, filling, landscaping and the like. Make allowance for compaction and settlement

Grade to minimum falls of 1:20 away from buildings within 1200 of building perimeter and 1:100 elsewhere unless noted otherwise. Negate surface water discharging

#### REQUIREMENT OF DETAILED EXCAVATION:

Excavate to the Contract depths and extent necessary to accomodate all foundation elements and any formwork, blinding concrete, working spaces and waterproofing processes

Landscaping scope of works and finishes to be confirmed by client prior to final quotation

Trim bottom of all excavations as necessary to attain the required levels, grades and profiles of the finished work

BATTERS: n accordance with NCC BCA Part 3.1.

### Hydraulic Notes

ALL WORKS shall be carried out in accordance with the following requirements:

- The Plumbing and Drainage Act 2002
- AS 3500 2003
- The Local Authority
- Any other authority have jurisdiction over any part of the works. - All subterranean services to be located prior to construction.

#### EXISTING SITE CONDITIONS:

The Contractor shall attend to existing services. Contractors are to inform themselves of existing

#### DESIGN LEVELS:

Design Levels shall be confirmed on site, prior to commencing installation of any pipework. Levels shown on drawings are recomended only. It shall be the Contractors responsibility to ensure

# that correct grades are attained at site. RAINWATER DRAINAGE:

ect all new rainwater drainage downpipes etc.. to the existing stormwater drainage system. RAINWATER GOODS: Refer to documentation for specification and finish.

Unless otherwise noted; new roofing sheeting, ridge cappings and valley flashings shall be metal with a colorbond finish. downpipes to be metal colorbond (min 0.5mm guage). Unless otherwise noted; new gutters, gutter spikes, barge rolls; new metal wall cladding;

associated flashings and cappings shall be metal with any "colorbond" finish nominat by the Designer MATERIAI S:

Water services shall be in accordance with Australian Standards.

# COVER PLATES:

Provide Cover Plates at all wall & floor penetrations

#### SANITARY PLUMBING:

Sanitary plumbing shall be UPVC Class HD with solvent weld joints and shall be laid at a minimum grade of 1:60 unless noted otherwise. Connect sanitary plumbing to council sewer in accordance with authority requirements.

#### INSULATION:

DIAL BEFORE YOU DIG:

It is the contractors responsibility to contact "Dial Before You Dig" Phone 1100 for the

All hot water lines shall be fully insulated.

location of existing public utilities prior to excavation. ENCASING OF UNDERGROUND SERVICES: All underground water and fire services shall be encased in 100mm of sand

#### Hydraulic Notes

AUTHORITIES FEES AND CHARGES:

e Contractor shall allow to pay all authorities fees & charges associated with new connections

To provide necessary flashings to windows and openings. Plumbing to be carried by a licenced plumber and in accordance

with the requirement of local authorities. The contractor shall be responsable for all permits and approvals. All hot water lines shall be fully

insulated. Sanitary Plumbing shall be connected to existing system with materials approved by the local authority. Builder and Sub-contractor to ensure all stormwater drains and sewer pipes are located at sufficient distance from any building footings

and/or slab edge beams to prevent moisture penetration, dampness, weakening or undermining

HOT WATER SUPPLY: All domestic hot water to basins, showers and baths to have maximum temperature of

50°C. Allow to supply and install tempering valves where required, as nominated in the NCC BCA and relevant standards

SUPPLY: Electrical contractor to provide phased supply to main switchboard and assess m demand to AS3000.

DISTRIBUTION BOARD: Provide new distribution board if required. All electrical outlets shall be protected by overcurrent/earth leakage circuit breakers in accordance with Australian Standards WIRING: Electrical conductors and wiring used for electrical services shall be in accordance with NCC BCA and Australian standards. All wiring shall be concealed where possible. Where exposed wiring is unavoidable, wiring must be concealed within suitable conduit.

ARTIFICIAL LIGHTING: Provide a system of artificial lighting to comply with AS1680 to all rooms not naturally lit.

LIGHTING: All luminaires shall be ceiling mounted unless otherwise required by owner If provided, refer to the schematic electrical plan for mounting heights of exterior wall mounted luminaires and layout of luminaires as indicated on reflected ceiling drawing. All flourescent lamps shall be cool white unless requested otherwise

FINAL LOCATIONS: If provided, refer to drawings for specific locations of accessories

- ELECTRICAL INSTALLATION: includes: - installation of distribution switchboard (if required)
- light and power installation
- light fittings, sub circuit wiring and lighting accessories socket outlets, special purpose power and subcircuit cabling
- installation of ciruits for air conditioning
   installation of ciruits and connection of all equipment (eg kitchen equipment)

- supply and installation of new outlet + wiring to roof mounted tv antenna.

ELECTRICAL ACCESSORIES: includes: switches and powerpoints. unless otherwise noted

all controls, switches and powerpoints shall be "pure white ". light switches - 1200 above floor level unless noted otherwise and located

ROOFTOP ANTENNA: All new relevant outlets to be wired to antenna. NETWORK & DATA: All phone networks and data points to be min cat6 cable connected to wall sockets. Cable runs to be concealed. If provided refer

to electrical layouts for locations. SWITCHES: Some light switches may require dimmers. Confirm with client prior to final quotation

# Joinery Notes

JOINERY ITEMS SHALL INCLUDE: Manufactured casework items, including: cabinets and cupboards. APPLIANCES & EQUIPMENT: Builder to co-ordinate all appliance and equipment locations on site

Installation and final connection by the contractor. Joiner to confirm all appliance and equipment rances and requirements in joinery prior to fabrication.

#### SITE MEASURE: All joinery to be site measured once linings are in place Confirm any discrepencies prior to fabrication

Fire Safety

GENERAL: Fire safety in accordance with part 3.7 of the NCC BCA SMOKE ALARMS: In accordance with part 3.7.5 of the BCA & A.S 3786 to be hard wired to consumer supply. Smoke dectors to be of the

type with alarms wired together and having a battery back-up

FIRE ALARM INSTALLATION: Install smoke detection, in the area affected by the works, to suit the requirements of AS1670 and the BCA. Provide any additional detection to areas to allow for compliance with AS1670 and the

BUILDER: To provide electricians installation certificate

Energy Efficiency

WORKS: In accordance with BCA Environmental guidelines.

LUMINAIRES: All lamps to luminaires shall be energy efficient lamps to suit specific luminaire EXTERNAL WALL: In accordance with BCA Environmental guidelines. Installed as per manufacturers instructions.

All external walls to have vapour permeable sarking

Weatherproof seals to all external doors.

NEW ROOF: In accordance with NCC BCA Environmental guidelines. Installed as per manufacturers instructions. TIMBER FLOORS: (Where applicable) In accordance with NCC BCA Environmental guidelines.

Installed as per manufacturers instructions.

All exposed timber floors to have required insulation to underside as per Basix Certificate. LIGHT & VENTILATION: In accordance with parts 3.8.4 and 3.8.5 of the NCC BCA plus relevant A.S. SOUND: Insulation in accordance with part 3.8.6 of the NCC BCA

# 450mm EAVE OVERHANG 150mm EAVE OVERHANG TO ALFRESCO ROOFLINE RAKED CEILING LINE OVER FAMILY/DINING SKYSPAN DOUBLE GLAZED 30 DEGREE ROOF PITCH CLISTOM ORB COLORBOND ROOF SHEELING & MAIN ROOF ABOVE VERANDAH **ROOF AREA** AREA: 406.49 m<sup>2</sup> 1. **DWELLING 2 - ROOF PLAN**

-450mm EAVE OVERHANG

#### DRAWING TO SCALE ON A3 SIZE SHEET FORMAT ONLY

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All boundaries and contours are subject to survey. All levels to AHD. It is the contractors responsibility to confirm all measurements on site and locations of any services prior to work on site

All documents are subject to Australian Copyright Law

14.6.21 PRELIMINARY ISSUE DATE DESCRIPTION

BUILDING CLASSIFICATION:



#### Preferred Design & Drafting 30 Lewis Stree

Mudgee NSW 2850 ph: 0263724397 Mob: 0429600160 email: marian@preferred-design.com.au

ACCREDITED CHARTERED MEMBER OF BUILDING DESIGNERS AUSTRALIA

II

SITE AREA: DATE: 14.6.21 DRAWN-M Palmer SCALE: 1:100, 1:250

DRAWING No: 16

PROJECT No: 112.21

D.P. NUMBER: DP 37470

1854m2 PROJECT: PROPOSED DUAL OCCUPANCY -

ADDITIONS & RENOVATIONS TO EXISTING DWELLING SITE ADDRESS:

# 4 BURRUNDULLA AVE MUDGEE

**CLIENT:** 3MJ DEVELOPMENTS P/L

SHEET DESCRIPTION: DWELLING 2 - ROOF PLAN, GENERAL NOTES

28.8.21 D.A. DOCUMENTATION

DOOR LI	ST				DOOR LIST					
ID	HEIGHT	WIDTH	ELEVATION	NOTES	ID	HEIGHT	WIDTH	ELEVATION	NOTES	
D-1-01	2,040	1,440			D-1-07	2,040	820			
D-1-02	2,400	3,000			D-2-01	2,100	1,500			
D-1-03	2,400	1,540			D-2-02	2,100	3,600			
D-1-04	2,340	820			D-2-03	2,100	2,100	<b>←</b> -¬		
D-1-05	3,050	5,500	1		D-2-04	2,100	2,100			
					D-2-05	2,040	820			
D-1-06	2,040	820	9-							

DOOR	DOOR LIST							
ID	HEIGHT	WIDTH	ELEVATION	NOTES				
D-2-06	2,040	820						

**DOOR LIST** 

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B 28.8.21 D.A. DOCUMENTATION

A 14.6.21 PRELIMINARY ISSUE DATE DESCRIPTION BUILDING CLASSIFICATION: 1a



# Preferred Design & Drafting

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email: marian@preferred-design.com.au ACCREDITED CHARTERED MEMBER OF BUILDING DESIGNERS AUSTRALIA

DATE: 14.6.21 DRAWN: M Palmer SCALE: 1:100, 1:250

D.P. NUMBER: DP 37470

1854m2

SITE AREA:

DRAWING No: 17

**CLIENT:** 3MJ DEVELOPMENTS P/L

**PROJECT:** PROPOSED DUAL OCCUPANCY -ADDITIONS & RENOVATIONS TO EXISTING DWELLING

**SITE ADDRESS:** 

4 BURRUNDULLA AVE MUDGEE

**SHEET DESCRIPTION:** 

PROJECT No: 112.21

DOOR LIST

WINDOV	V LIST				WINDOW LIST				WINDOW	WINDOW LIST				
ID	HEIGHT	WIDTH	ELEVATIONS	NOTES	ID	HEIGHT	WIDTH	ELEVATIONS	NOTES	ID	HEIGHT	WIDTH	ELEVATIONS	NOTES
W-1-01	1,800	600			W-1-11	1,200	600			W-2-07	1,800	1,500		
W-1-02	1,800	1,600			W-1-12	1,400	900			W-2-08	600	1,800		
	,***	,,,,,,			W-1-13	1,600	1,600			W-2-09	1,200	1,800		
W-1-03	1,800	1,600			W-1-14	1,600	900			W-2-10	1,200	2,100		
W-1-04	1,800	1,600			W 0 04	4 000	000			W-2-11	1,200	1,800		
W-1-05	1,800	1,600			W-2-01	1,800	900			W-2-12	900	900		
					W-2-02	1,800	900			W-2-13	1,200	1,800		
W-1-06	1,800	600			W-2-03	1,800	2,400			W-2-14	600	1,800		
W-1-07	2,400	600			W-2-04	1,800	900			W-2-15	1,200	2,100	<b>←</b>	
										W-2-16	900	600		
W-1-08	2,400	600			W-2-05	1,800	900			W-2-17	1,200	2,100		
					W-2-06	1 800	1,500			W-2-18	600	2,400		
W-1-09	1,200	600			200	.,000	1,000				4 000			
W-1-10	600	1,500								W-2-19	1,800	600		

**WINDOW LIST** 

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B 28.8.21 D.A. DOCUMENTATION A 14.6.21 PRELIMINARY ISSUE DATE DESCRIPTION

BUILDING CLASSIFICATION: 1a



# Preferred Design & Drafting

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ACCREDITED CHARTERED MEMBER OF BUILDING DESIGNERS AUSTRALIA



D.P. NUMBER: DP 37470 SITE AREA: 1854m2 14.6.21

DATE: DRAWN: M Palmer SCALE: 1:100, 1:250

DRAWING No: 18 PROJECT No: 112.21 **CLIENT:** 3MJ DEVELOPMENTS P/L


PROJECT: PROPOSED DUAL OCCUPANCY -ADDITIONS & RENOVATIONS TO EXISTING DWELLING


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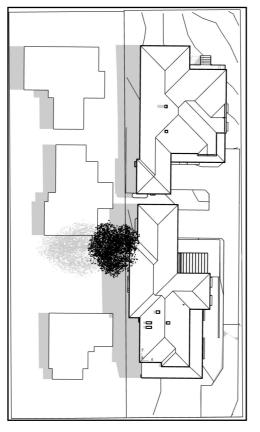
4 BURRUNDULLA AVE MUDGEE


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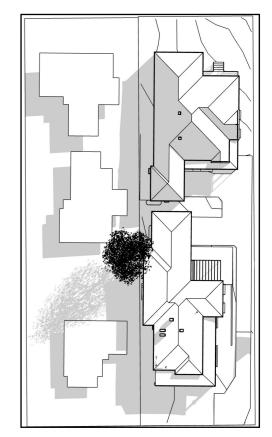
WINDOW LIST





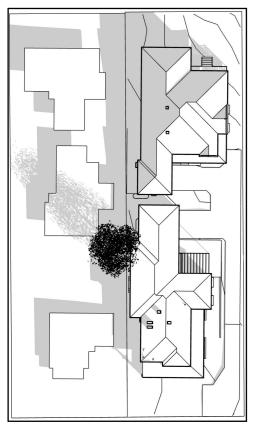

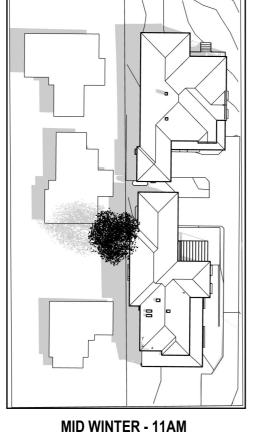

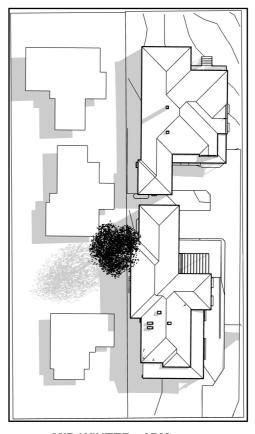



**MID WINTER - 9AM** 


MID WINTER - 12PM

MID WINTER - 2PM

MID WINTER - 3PM

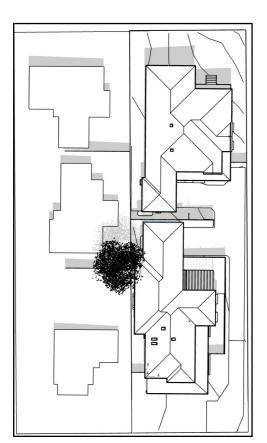

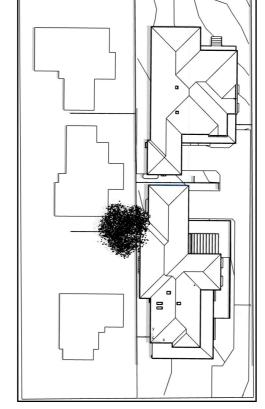

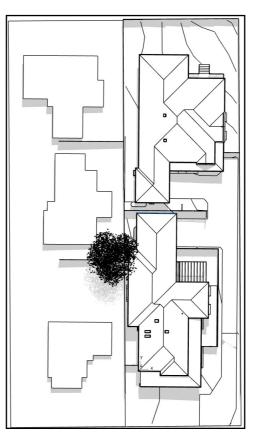



**MID SUMMER - 9AM** 

**MID SUMMER - 12PM** 

MID SUMMER - 3PM

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B 28.8.21 D.A. DOCUMENTATION A 14.6.21 PRELIMINARY ISSUE DATE DESCRIPTION

BUILDING CLASSIFICATION:





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ACCREDITED CHARTERED MEMBER OF BUILDING DESIGNERS AUSTRALIA



D.P. NUMBER: DP 37470 SITE AREA: 1854m2 DATE: 14.6.21

DRAWN: M Palmer SCALE: 1:100, 1:250

DRAWING No: 19 PROJECT No: 112.21 **CLIENT:** 3MJ DEVELOPMENTS P/L


**PROJECT:** PROPOSED DUAL OCCUPANCY -ADDITIONS & RENOVATIONS TO EXISTING DWELLING

**SITE ADDRESS:** 

SHADOW DIAGRAMS

4 BURRUNDULLA AVE MUDGEE

**SHEET DESCRIPTION:** 

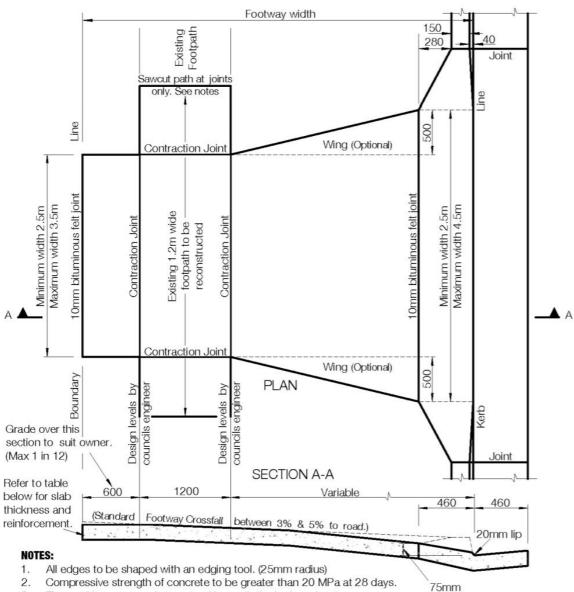

- The road base course is to extend beneath the kerb and gutter.
- Mastic joints to be placed not more than 6m or less than 4m apart.
- 5. All reinforcement is to have a minimum of 50mm cover.
- Laybacks to be constructed in plain concrete only.
- Adjacent ground for all works to be within 25mm of any finished level. 65mm kerb may be required for steep adjacent grades to protect prams and wheelchairs.
- Nature stripe is to be adjusted to new crossing. No grade to be greater than 1 in 8.
- Reconstruct existing path to achieve a grade no steeper than 1 in 33 (A.S.1428). Where this is not possible a grade of 1 in 14 can be used for no more than 9m however further conditions will be required. See Councils crossing engineer for information and specific requirements.


CROSSING TYPE	SLAB THICKNESS & REINFORCEMENT	LAYBACK THICKNESS & REINFORCEMENT
RESIDENTIAL	125mm, SL62	150mm
RESIDENTIAL H.D.	150mm, SL82	150mm, SL82
COMMERCIAL	200mm, 2*SL82	200mm, 2*SL82

28.8.21 D.A. DOCUMENTATION

PRELIMINARY

14.6.21

ISSUE DATE DESCRIPTION

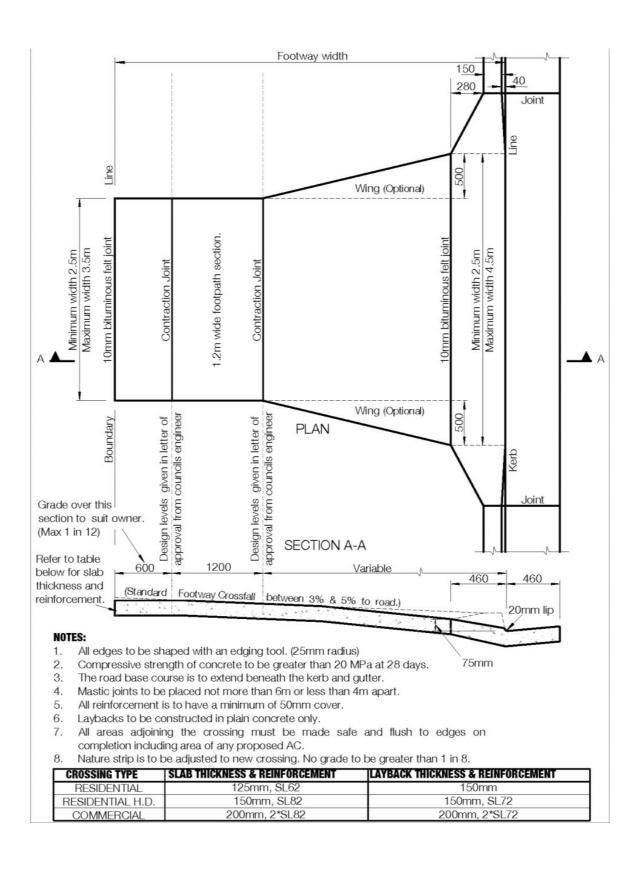

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**BUILDING CLASSIFICATION:** 

## **Preferred Design** & Drafting

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SITE AREA: DATE:

14.6.21 DRAWN-M Palmer SCALE: 1:100, 1:250

PROJECT No: 112.21

1854m2

D.P. NUMBER: DP 37470

DRAWING No: 20

**CLIENT:** 3MJ DEVELOPMENTS P/L

PROJECT: PROPOSED DUAL OCCUPANCY -ADDITIONS & RENOVATIONS TO EXISTING DWELLING

SITE ADDRESS:

4 BURRUNDULLA AVE MUDGEE

SHEET DESCRIPTION: DRIVEWAY DETAIL